verizon^v

8921 RESEARCH DRIVE CHARLOTTE, NC 28262


SITTON

SITE ADDRESS

PRATER FARM ROAD **SENECA, SC 28676** OCONEE COUNTY

LATITUDE: 34° 36' 45.442" N LONGITUDE: 82° 58' 49.489" W

TAX/PIN #: 2910002012 **ZONING: UNZONED**

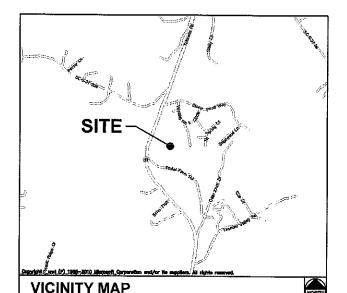

FROM CHARLOTTE OFFICE: START OUT GOING SOUTHWEST ON RESEARCH DRIVE TOWARDS HARRIS BLVD, FOR 0.4 MI: TURN LEFT ONTO W. WT HARRIS BLVD. / NC-24-E, FOR 0.3 MI; TURN RIGHT AND MERGE ON I-85 S. 140.3 MI; TAKE EXIT 11 AND TURN RIGHT ON SC-24 W. 10.0 MI; SLIGHT RIGHT ON CROSS ROADS DR. 0.5 MI; MERGE ON SC-59 N. 0.8 MI; TURN RIGHT ON PRATER FARM RD. 0.1 MI; DESTINATION ON THE LEFT.

DRIVING DIRECTIONS

MUNICIPALITY: OCONEE COUNTY

STATE: SOUTH CAROLINA

TOWER TYPE: MONOPOLE TOWER

TOWER HEIGHT: 165' (174' TO HIGHEST APPURTENANCE)

NUMBER OF CARRIERS: 0 EXISTING, 1 PROPOSED

USE:

PROPOSED TELECOMMUNICATIONS TOWER AND UNMANNED EQUIPMENT

CONSULTANT

KIMLEY-HORN AND ASSOCIATES, INC. 2 SUN COURT, SUITE 450 PEACHTREE CORNERS, GEORGIA 30092 PHONE: (678) 533-3928 ATTN.: KEITH MARKLAND

PROJECT SUMMARY

DEVELOPER VERIZON WIRELESS 8921 RESEARCH DRIVE **CHARLOTTE, NC 28262**

PHONE: (704) 577-8785 ATTN: MICHAEL HAVEN

POWER COMPANY DUKE POWER

PHONE: (800) 777-9898 ATTN.: CUSTOMER SERVICE

TELEPHONE COMPANY AT&T

PHONE: (336) 286-6000 ATTN.: CUSTOMER SERVICE

PROPERTY OR TOWER OWNER KENNETH EARL PRATER 8541 FREENY VALLEY ROAD CADDO, OK 74729 PHONE: (864) 972-9377 ATTN.: DONALD PRATER

CONTACTS

SHEET	DESCRIPTION	REV.
T1	COVER SHEET	3
	SITE SURVEY (SHEET 1 OF 3)	4
	SITE SURVEY (SHEET 2 OF 3)	4
	SITE SURVEY (SHEET 3 OF 3)	4
N1	GENERAL NOTES	0
C1	OVERALL SITE PLAN	2
C2	SITE PLAN	2
C3	EQUIPMENT PAD LAYOUT	1
C4	EQUIPMENT PAD FOUNDATION SECTION DETAILS	1
C5	EQUIPMENT PAD FOUNDATION SECTION DETAILS	1
C6	FENCE, GATE, AND COMPOUND DETAILS	1
C7	GRADING AND EROSION CONTROL PLAN 1 OF 2	1
C8	GRADING AND EROSION CONTROL PLAN 2 OF 2	-1
C9	GRADING AND EROSION CONTROL DETAILS	1
C10	ACCESS ROAD DETAILS	1
C11	SITE SIGNAGE DETAILS	1
C12	WAVEGUIDE BRIDGE DETAILS	1
C13	ANTENNA AND TOWER ELEVATION DETAILS	2
L1	LANDSCAPING PLAN AND NOTES	0
EO	NOTES AND SPECIFICATIONS	1
E1	BASIC SERVICE ROUTING PLAN	1
E2	GROUNDING PLAN	1
E3	SINGLE-LINE DIAGRAM	1
E4	ELECTRICAL DETAILS	1
E5	ELECTRICAL DETAILS	1
E6	ELECTRICAL DETAILS	1
E7	GROUNDING DETAILS	1
E8	ELECTRICAL DETAILS	1
E9	ELECTRICAL DETAILS	1
E10	ELECTRICAL DETAILS	1
SHE	ET INDEX	

OCONEE COUNTY COMMUNITY DEVELOPMENT DEPT.

415 PINE ST.

ATTN.: ZONING

WALHALLA, SC 29691

PHONE: (864) 638-4218

PERMIT INFORMATION

PROJECT INFORMATION: **VERIZON NAME: SITTON VERIZON No.: TBD** PRATER FARM ROAD SENECA, SC 28678 OCONEE COUNTY

CURRENT ISSUE DATE:

8921 RESEARCH DRIVE CHARLOTTE, NORTH CAROLINA

02/16/17

CONSTRUCTION

REV.:=DATE:====SSUED FOR:= 0 11/04/14 CONSTRUCTION WCE 1 08/01/16 CONSTRUCTION WCE 2 10/21/16 CONSTRUCTION WCE 3 02/16/17 CONSTRUCTION WCE

Kimley Morn

2 SUN COURT, SUITE 450
PEACHTREE CORNERS, GA 30092
PHONE: 770-825-0744
WWW.KIMLEY-HORN.COM
SC License C00166

CONSULTANT:



DRAWN BY: CHK .: = KRM

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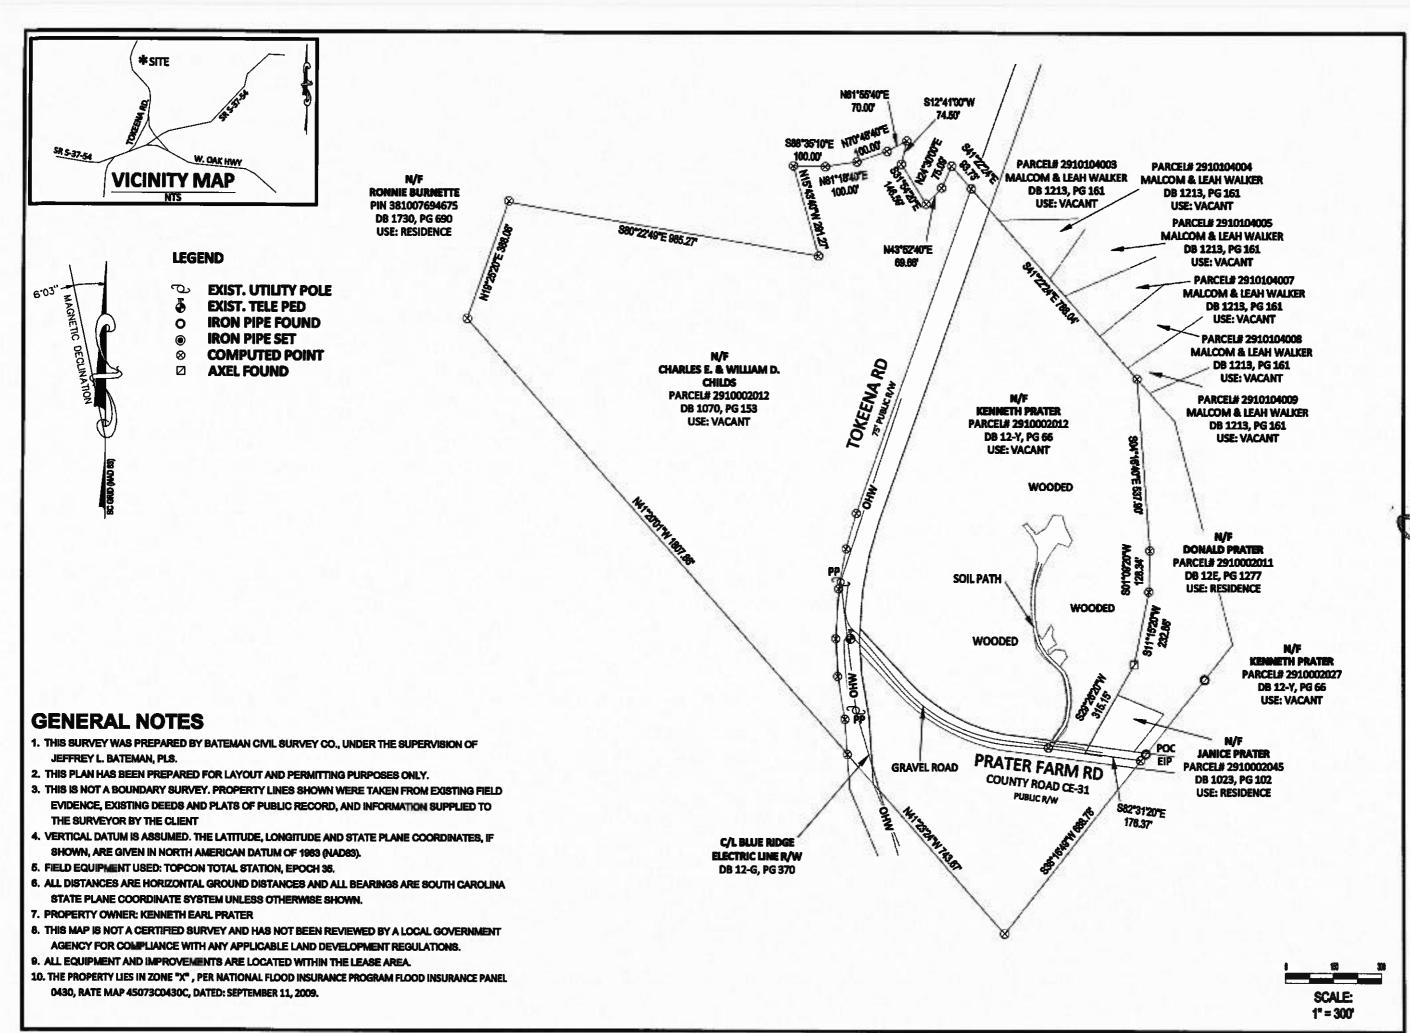
SHEET TILE:

COVER SHEET

SHEET NUMBER:

018985125

REVISION:





an Civil Survey Co, PC 200 N Linin St, Holly Springs, NC 27540 Phone: 919.677,1080 Page 919.677,1081 NCSLS PRIM & C-2579





DRAWN BY: JCH CHECKED BY: JLB DRAWING DATE::00/29/2014



_		_	_				
	DESCRIPTION	Issue Final Survey	Revise 30° lessee language	Address Title comments	12/10/14 Issue Final Survey		
REVISIONS	DATE	11/04/14	11/12/14	11/24/14	12/10/14		
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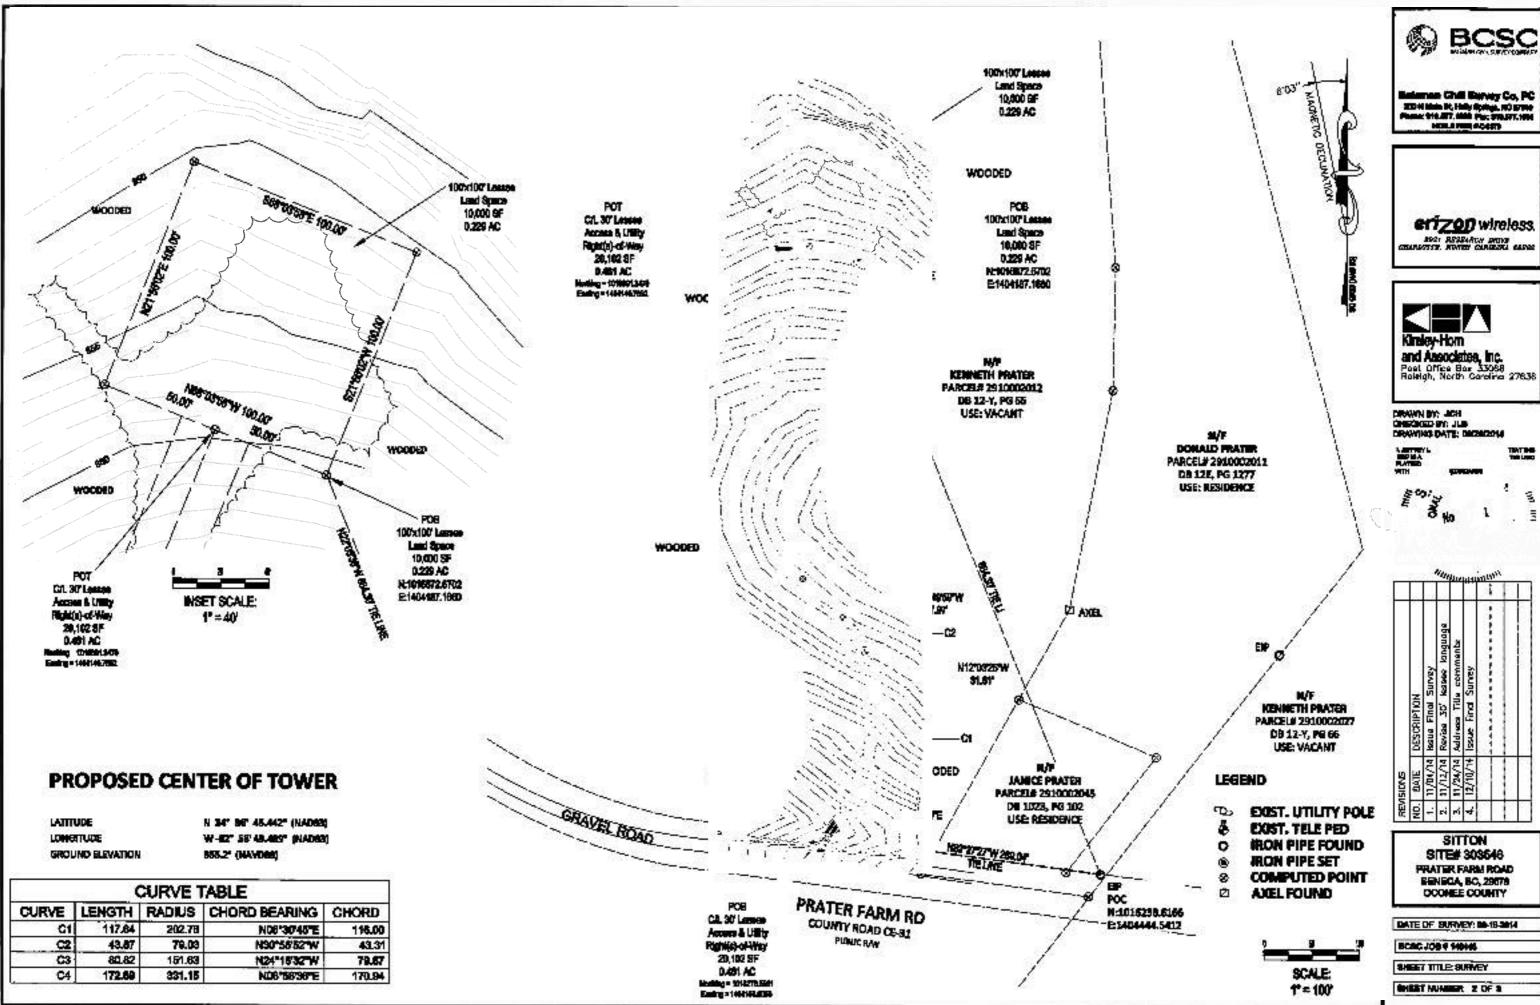
SITTON SITE# 303546 PRATER FARM ROAD **SENECA, SC, 29678** OCONEE COUNTY

DATE OF SURVEY: 09-16-2014

BCSC JOB # 140448

SHEET TITLE: SURVEY

SHEET NUMBER 1 OF 3





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		330	000			1	
	DESCRIPTION	besue Final Survey	Revise 35' lessee language	Address Tills comments	Issue Find Suney		
REVISIONS	DATE	11/04/14	11/12/14	11/24/14	12/10/14		
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C/L 30" LESSEE ACCESS & UTILITY RIGHT(\$)-OF-WAY DESCRIPTION

All that certain parcel of land, situated in Seneca, Oconee County, South Carolina, being on the lands of Kenneth Preter as described in DB 12-Y, PG 65, Oconea County Records, and being more particularly described as follows:

Commencing at the SouthEastern property corner of Donald Prater and NorthEastern property corner of Kenneth Prater, Oconee County Records, said corner also being on the Northern Right-of-Way of Prater Farm Road having State Plane Coordinates N:1016238.6168, E:1404444.5412, thence N82°27'27'W, 289.04' to a point, said point being the Point of Beginning of the C/L 30' Lessee Access & Utility Right(s)-of-Way, said point having State Plane Coordinates N:1016276.6581 and E:1404158.0058; thence N36°00'40"E, 83.75" to a point of curvature; thence along a curve to the Left having a radius of 202.76", a length of 117.64", a chord of N06"30"45"E, 116.00" to a point; thence N12*03*25*W, 31.61* to a point of curvature; thence along a curve to the Left. having a radius of 79.03", a length of 43.87", a chord of N30*55'52"W, 43.31" to a point; thence N46*48'56"W, 57.97" to a point of curvature; thence along a curve to the Right having a radius of 151.63', a length of 80.82', a chord of N24"16'32"W, 79.87' to a point; thence N06*2451"W, 44.26" to a point of curvature; thence along a curve to the Right having a reditts of 331.15", a length of 172.69", a chord of N06"58"36"E, 170.94" to a point; thence N22°21'54"E, 64.41" to a point; said point being the Point of Terminus of the C/L 30" Lessee Access & Utility Right(s)-of-Way having State Plane Coordinates N 1016891.3470, E 1404140.7852 Sald C/L 30 Leesee Access & Utility Right(s)-of-Way contains 20,102 equare feet more or less.

LESSEE LAND SPACE DESCRIPTION

All that certain parcel of land, situated in Seneca, Oconee County, South Carolina, being on the lands of Kenneth Prater as described In DB 12-Y, PG 66, Oconee County Records, and being more particularly described as follows:

Commencing at the SouthEastern property corner of Donald Prater and NorthEastern property corner of Kenneth Prater, Oconee County Records, said corner also being on the Northern Right-of-Way of Prater Farm Road having State Plane Coordinates N:1016238.6166, E:1404444.5412, thence N22°05'36"W, 684.30' to a point, the Point of Beginning of the Lessee Land Space: thence N68°03'58"W, 100.00' to a point; thence N21°56'02"E, 100.00' to a point; thence S68°03'58"E, 100.00' to a point; thence S21°56'02"W. 100.00' to a point: said point being the Point of Beginning of the Lessee Land Space. Said Lessee Land Space contains 10,000 square feet, more or less.

> REPORT OF TITLE FIDELITY NATIONAL TITLE INSURANCE COMPANY D: VERIZON WIRELESS

- 1. Taxes calendar year:2013 Amount: \$324.01 annually Parcel ID #: 291-00-02-012 Paid through: 2013 Assessment: \$1,370.00 (total = land and improvements, if any) (Does Not Affect Vertzon Wireless Land Space or Rights of Way)
- 2. Plat recorded in Deed Book 40, Page 04. (As shown on Survey)
- 3. Electric Line Right-of-Way Easement In favor of: Blue Ridge Electric Cooperative, Inc. Recorded on: 08/08/1979 Recorded in: Deed Book 12-G, Page 370 (Does Not Affect Vertzon Wireless' Land Space or Rights of Way)



on Civil Survey Co, PC 200 N Mets St. Holly Springs, NC 27540 Phone: 919.577.1000 Parc 919.577,1001 HCBLB FIRM # 0-2275





DRAWN BY: JCH CHECKED BY: JLB DRAWING DATE: 09/29/2014



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	DESCRIPTION	Issue Final Survey	Revise 30' lessee language	Address Title comments	Issue Final Survey		
REVISIONS	DATE	11/04/14	11/12/14	11/24/14	12/10/14		
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SITTON SITE# 303546 PRATER FARM ROAD SENECA, SC, 29678 OCONEE COUNTY

DATE OF SURVEY: 09-18-2014

BC8C JOB # 140448

SHEET TITLE: SURVEY

SHEET NUMBER 3 OF 3

1.00 GENERAL NOTES

- 1.01 ALL MATERIALS AND WORKMANSHIP SHALL CONFORM TO THE DRAWINGS AND SPECIFICATIONS. ALL WORK SHALL BE DONE IN ACCORDANCE WITH THE LATEST EDITION OF THE STATE, LOCAL AND NATIONAL CODES, ORDINANCES AND OR REGULATIONS APPLICABLE TO THIS PROJECT.
- 1.02 THE CONTRACTOR SHALL BE RESPONSIBLE FOR COORDINATING THE WORK OF ALL TRADES AND SHALL CHECK ALL DIMENSIONS, ALL DISCREPANCIES SHALL BE CALLED TO THE ATTENTION OF THE PROJECT MANAGER AND/OR ENGINEER AND BE RESOLVED BEFORE PROCEEDING WITH WORK. WHERE THERE IS A CONFLICT BETWEEN DRAWING AND VERIZON SPECIFICATIONS, THE VERIZON PROJECT ENGINEER SHOULD BE CONTACTED FOR CLARIFICATION.
- 1.03 ALL INFORMATION SHOWN ON THE DRAWINGS RELATIVE TO EXISTING CONDITIONS IS GIVEN AS THE BEST PRESENT KNOWLEDGE, BUT WITHOUT GUARANTEE OF ACCURACY, WHERE ACTUAL CONDITIONS CONFLICT WITH THE DRAWINGS, THEY SHALL BE REPORTED TO THE PROJECT MANAGER AND/OR ENGINEER SO THAT PROPER REVISIONS MAY BE MADE. MODIFICATION OF DETAILS OF CONSTRUCTION SHALL NOT BE MADE WITHOUT WRITTEN APPROVAL OF THE PROJECT MANAGER AND/OR ENGINEER.
- 1.04 CONTRACTOR SHALL REVIEW AND BE FAMILIAR WITH SITE CONDITIONS AS SHOWN ON THE ATTACHED SITE PLAN AND/OR SURVEY DRAWINGS.
- 1.05 WAVEGUIDE BRIDGE AND EQUIPMENT CABINETS ARE SHOWN FOR REFERENCE ONLY. REFER TO SEPARATE DRAWINGS FOR SPECIFIC INFORMATION.
- 1.06 ALL FINISHED GRADES SHALL SLOPE MINIMUM 1/4 IN./FT. AWAY FROM EQUIPMENT IN ALL DIRECTIONS. CONTRACTOR SHALL SLOPE SWALES AS REQUIRED ALONG EXISTING TERRAIN TO DRAIN AWAY FROM COMPOUND AND ACCESS DRIVE.
- 1.07 THE PROPOSED TOWER AND TOWER FOUNDATIONS WERE DESIGNED BY OTHERS. TOWER INFORMATION PROVIDED ON THESE PLANS ARE PROVIDED FOR REFERENCE PURPOSES ONLY. NOTIFY ENGINEER OR PROJECT MANAGER OF ANY CONFLICTS OR DISCREPANCIES. CONTRACTOR TO OBTAIN COPY OF TOWER DESIGN DRAWINGS, IF AVAILABLE, FROM VERIZON PROJECT MANAGER TO CONFIRM COAX ROUTING AND ANTENNA MOUNT INFORMATION.
- 1.08 THE CONTRACTOR SHALL PROVIDE ADEQUATE EXCAVATION SLOPING, SHORING, BRACING, AND GUYS IN ACCORDANCE WITH ALL NATIONAL, STATE, AND LOCAL SAFETY ORDINANCES.
- 1.09 UPON COMPLETION OF CONSTRUCTION, CONTRACTOR IS RESPONSIBLE FOR REPAIRING ANY DAMAGE CAUSED BY CONSTRUCTION ACTIVITIES TO THE EXISTING ACCESS ROAD AND COMPOUND GRAVEL AREAS. ANY NEW FILL MATERIALS SHALL BE COMPACTED.
- 1.10 THE CONTRACTOR IS HEREBY NOTIFIED THAT PRIOR TO COMMENCING CONSTRUCTION, HE IS RESPONSIBLE FOR CONTACTING THE UTILITY COMPANIES INVOLVED AND SHALL REQUEST A VERIFICATION AT THE CONSTRUCTION SITE OF THE LOCATIONS OF THEIR UNDERGROUND UTILITIES AND WHERE THEY MAY POSSIBLY CONFLICT WITH THE PLACEMENT OF IMPROVEMENTS AS SHOWN ON THESE PLANS. THE CONTRACTOR OR ANY SUBCONTRACTOR FOR THIS CONTRACT WILL BE REQUIRED TO NOTIFY "SOUTH CAROLINA 811" 72 HOURS IN ADVANCE OF PERFORMING ANY WORK BY CALLING THE TOLL FREE NUMBER (888) 721-7877 (OR 811). ANY UTILITIES DAMAGED BY CONSTRUCTION ACTIVITIES SHALL BE REPAIRED BY THE CONTRACTOR, AT NO EXPENSE TO THE OWNER.
- 1.11 CONTRACTOR TO PROVIDE DUMPSTER AND PORTABLE TOILET FACILITY DURING CONSTRUCTION.
- 1.12 CONTRACTOR TO PROVIDE STYMIE LOCK OR EQUIVALENT AS APPROVED BY VERIZON PROJECT MANAGER.
- 1.13 CONTRACTOR TO PROVIDE ANY NECESSARY SIGNAGE PER VERIZON PROJECT MANAGER'S INSTRUCTIONS. SEE DETAIL ON SHEET C10.

2.00 EQUIPMENT FOUNDATION NOTES

- 2.01 FOUNDATIONS ARE DESIGNED FOR A PRESUMPTIVE ALLOWABLE SOIL BEARING CAPACITY OF 2,000 PSF. CONTRACTOR SHALL VERIFY SOIL CONDITIONS AND BEARING CAPACITY PRIOR TO CONSTRUCTION.
- 2.02 EXCAVATE A MINIMUM 18" BELOW PROPOSED EQUIPMENT FOUNDATIONS OF EXPANSIVE, ORGANIC, UNCONSOLIDATED OR OTHERWISE UNACCEPTABLE MATERIAL AND REPLACE WITH WELL-COMPACTED MATERIAL ACCEPTABLE TO VERIZON.
- 2.03 CONTRACTOR SHALL BE RESPONSIBLE FOR LOCATING, PROTECTING, AND RELOCATING AS REQUIRED ALL SERVICE AND UTILITY LINES IN VICINITY OF THE WORK SITE. ALL EXCAVATIONS NEAR THESE LINES TO BE CARRIED OUT WITH EXTREME CAUTION, COORDINATE ALL RELOCATIONS WITH THE PROPERTY OWNER,
- 2.04 CONTRACTOR TO CUT/FILL EXISTING COMPOUND SUBSOIL TO PROVIDE AN AREA AS LEVEL AS POSSIBLE FOR THE EQUIPMENT FOUNDATIONS, ALL FILL AREAS ARE TO BE FILLED WITH SUITABLE MATERIALS, FILL MATERIALS ARE TO BE PLACED, COMPACTED, AND TESTED IN MAXIMUM LAYERS OF 8". COMPACTION OF ALL FILL MATERIAL SHALL ACHIEVE 95 PERCENT OF MAXIMUM DRY DENSITY AT OPTIMUM MOISTURE CONTENT IN ACCORDANCE WITH ASTM D 698. ALL TESTS MUST MEET THE MINIMUM SPECIFIED SOIL BEARING CAPACITY. COMPACTION TESTING IS BY THE GEOTECHNICAL TESTING COMPANY DESIGNATED FOR THE PROJECT. SCHEDULING AND COORDINATION IS THE RESPONSIBILITY OF THE GENERAL CONTRACTOR. REPORTS OF ALL TESTING ARE TO BE PROMPTLY DELIVERED OR FAXED TO THE VERIZON WIRELESS PROJECT
- 2.05 CONCRETE SHALL HAVE A MINIMUM COMPRESSIVE STRENGTH OF 4,000 PSI AT 28 DAYS AND SHALL BE INSTALLED IN ACCORDANCE WITH THE LATEST REVISION TO ACI-318 BUILDING CODE REQUIREMENTS FOR REINFORCED CONCRETE.
- 2.06 CONCRETE SHALL HAVE A SLUMP BETWEEN 3" AND 6".
- 2.07 REINFORCING BARS SHALL CONFORM TO THE LATEST REVISION OF ASTM-A615 GRADE 60 SPECIFICATIONS AND BE DETAILED IN ACCORDANCE WITH THE LATEST REVISION TO ACI-318.
- 2.08 AT THE REQUEST OF THE VERIZON WIRELESS PROJECT MANAGER. TEST CYLINDERS SHALL BE MOLDED AND LABORATORY CURED IN ACCORDANCE WITH ASTM C31. THREE CYLINDERS SHALL BE TAKEN FOR EACH DAY'S CONCRETE PLACEMENT. CYLINDERS SHALL BE TESTED IN ACCORDANCE WITH THE LATEST REVISION TO ASTM C39.
- 2.09 CHAMFER ALL EXPOSED EXTERNAL CORNERS OF CONCRETE WITH 34" x 45' CHAMFER, UNLESS OTHERWISE NOTED.
- 2.10 CONCRETE FORMWORK IS TO BE STRIPPED WITHIN 48 HOURS. VIBRATION OF THE CONCRETE MUST ASSURE THAT HONEYCOMBING WILL BE AT A MINIMUM. MECHANICAL VIBRATION OF ALL CONCRETE IS REQUIRED UNLESS OTHERWISE DIRECTED BY VERIZON WIRELESS' PROJECT MANAGER. ABOVE GRADE CONCRETE IS TO BE RUBBED AND PATCHED TO ASSURE SMOOTH FINISH AT TIME OF FORMS REMOVAL, CONTRACTOR SHALL PROVIDE A BROOM FINISH ON THE TOP SURFACE OF THE EQUIPMENT FOUNDATION UNLESS OTHERWISE DIRECTED BY VERIZON WIRELESS' PROJECT MANAGER.
- 2.11 TOPS OF CONCRETE FOUNDATION MUST BE WITHIN 0.02' OF ELEVATION REQUIRED.
- 2.12 TOP OF FOUNDATION FINISH TO BE LEVEL ±1/2" IN 10'.
- 2.13 TOP OF FOUNDATION TO HAVE MEDIUM BROOM FINISH.
- 2.14 CONTRACTOR SHALL REFER TO DRAWINGS OF OTHER TRADES AND VENDOR DRAWINGS FOR EMBEDDED ITEMS AND RECESSES NOT SHOWN ON THE STRUCTURAL DRAWINGS. CONTRACTOR SHALL VERIFY PLACEMENT OF EQUIPMENT AND LOCATION OF CONDUIT FOR MANUFACTURER'S AND VENDORS SPECIFICATIONS, IT SHALL BE THE RESPONSIBILITY OF THE CONTRACTOR TO PROVIDE ALL OPENINGS AND SLEEVES FOR PROPER DISTRIBUTION OF ALL UTILITIES.



8921 RESEARCH DRIVE CHARLOTTE, NORTH CAROLINA 28262

PROJECT INFORMATION:

VERIZON NAME: SITTON VERIZON No.: TBD

> PRATER FARM ROAD SENECA, SC 28678 OCONEE COUNTY

CURRENT ISSUE DATE:

08/01/16

SSUED FOR:

CONSTRUCTION

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Kimley Horn


2 SUN COURT, SUITE 450 PEACHTREE CORNERS, GA 30092 PHONE: 770-825-0744 WWW.KIMLEY-HORN.COM SC License C00166

CONSULTANT:

CONSULTANT:



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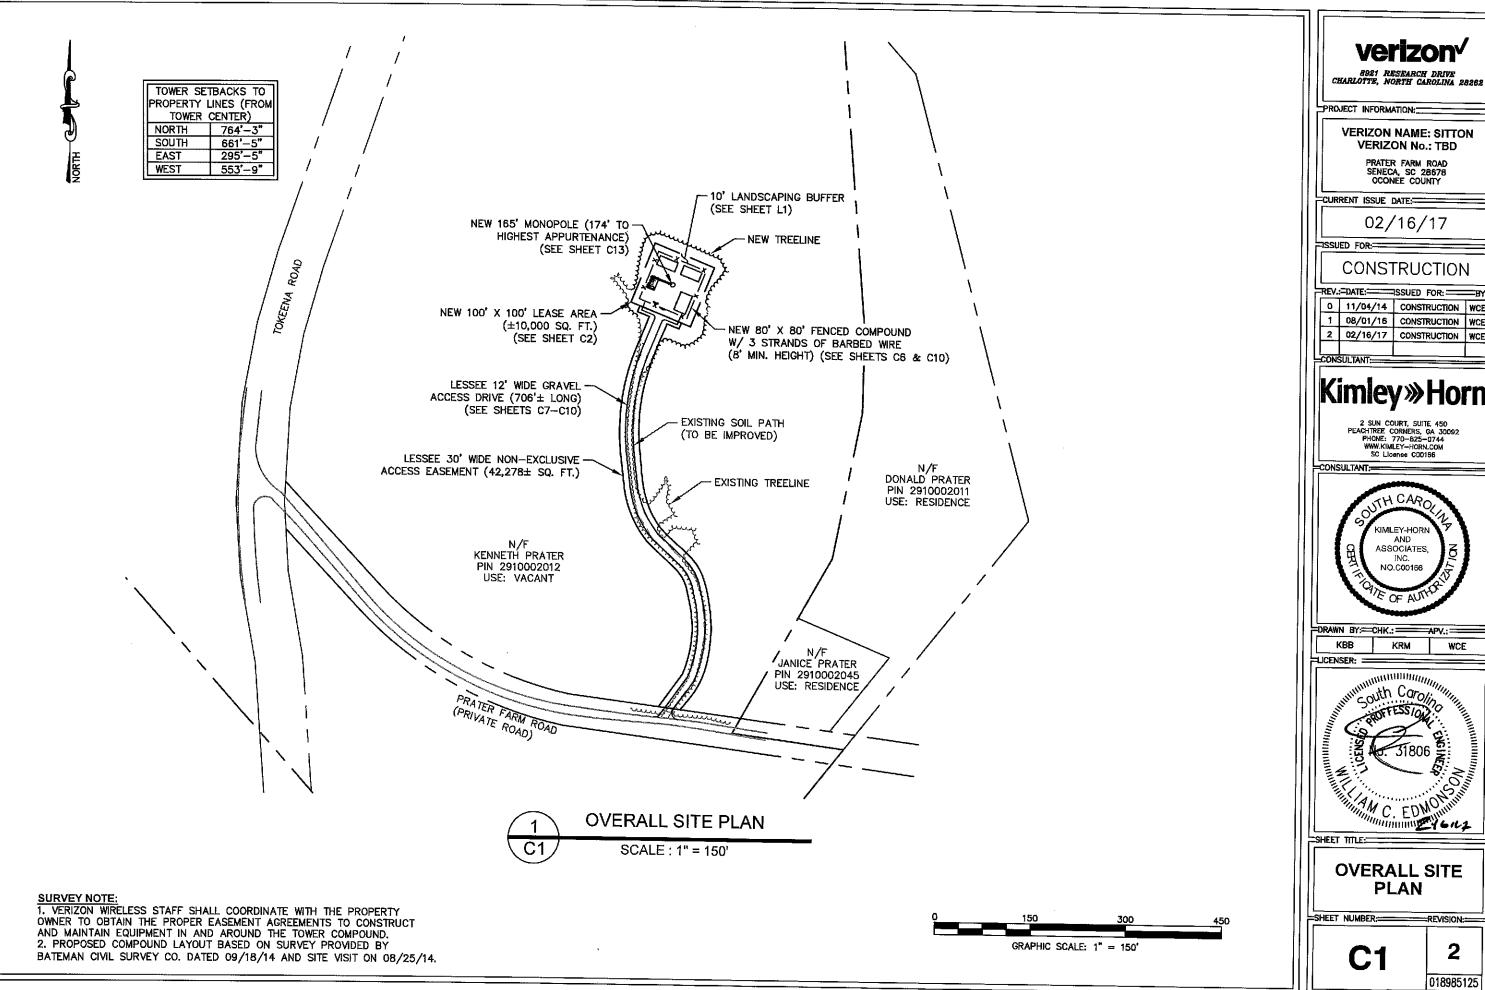
GENERAL NOTES

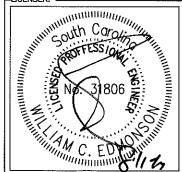SHEET NUMBER:

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REVISION:

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VERIZON NAME: SITTON VERIZON No.: TBD

PRATER FARM ROAD SENECA, SC 28678 OCONEE COUNTY

02/16/17

CONSTRUCTION

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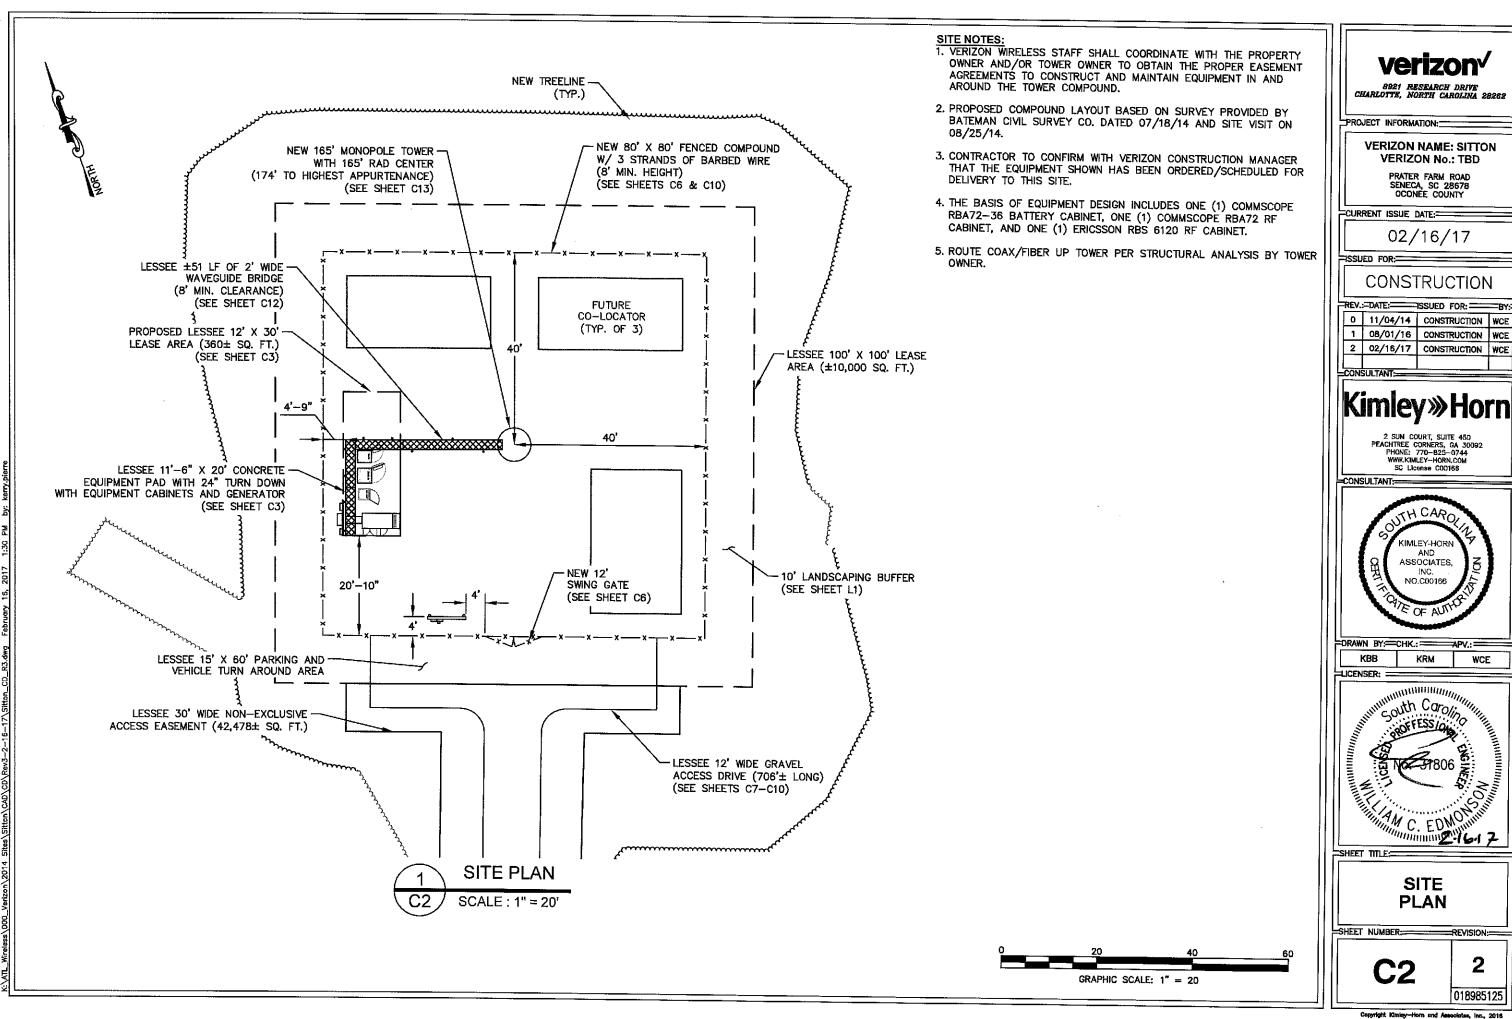
Kimley»Horn

2 SUN COURT, SUITE 450
PEACHTREE CORNERS, GA 30092
PHONE: 770-825-0744
WWW.KIMLEY-HORN.COM
SC License C00166





OVERALL SITE PLAN



verizon

VERIZON No.: TBD


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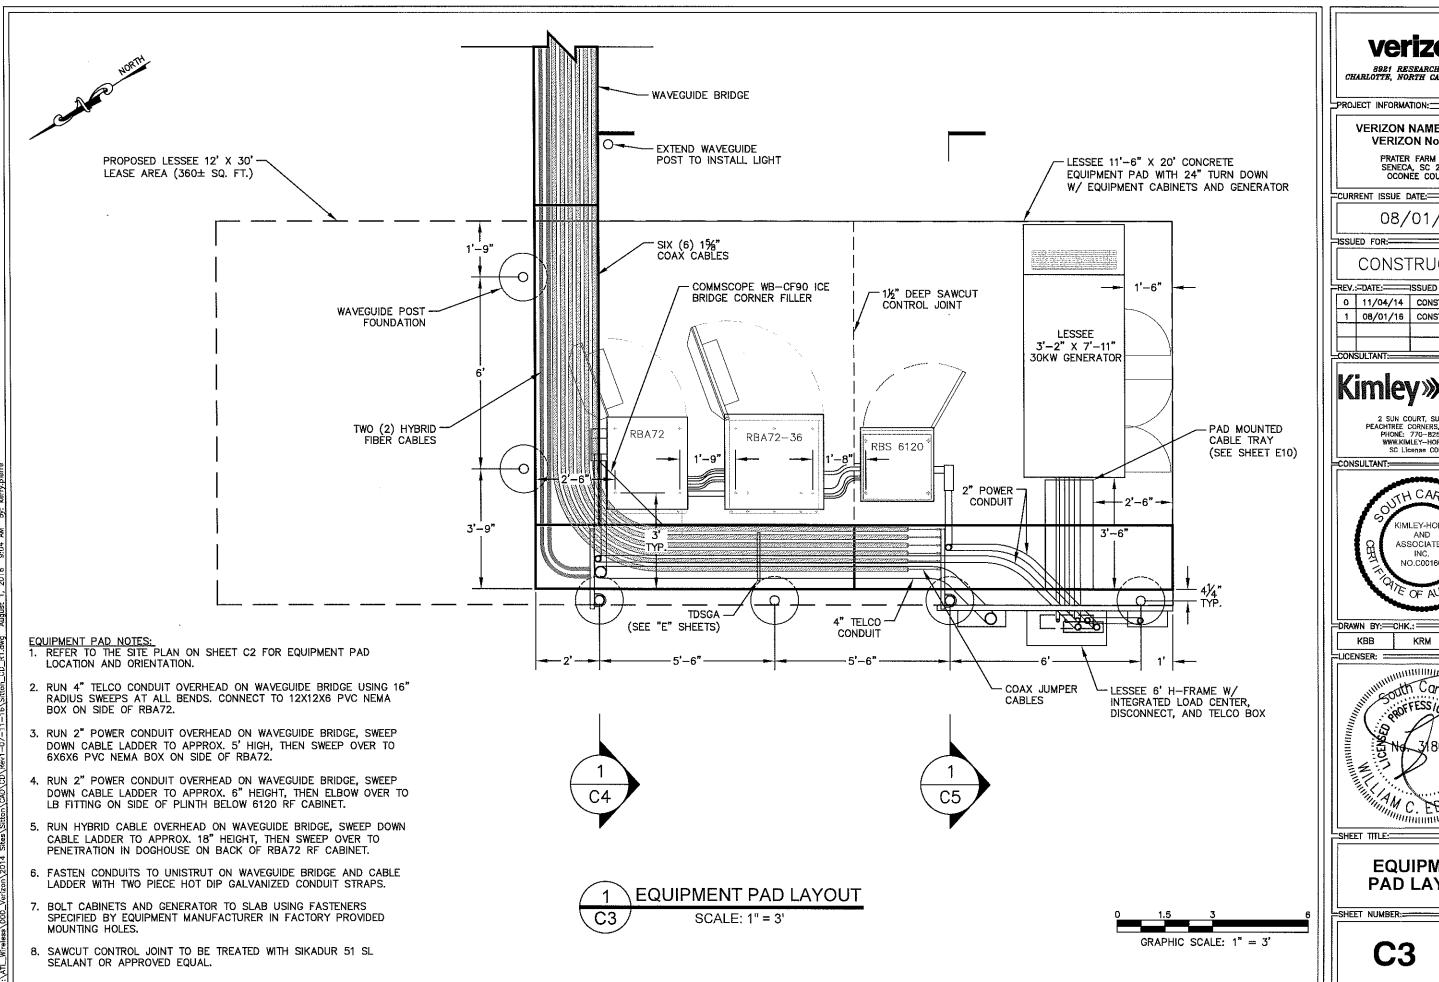
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Kimley Morn



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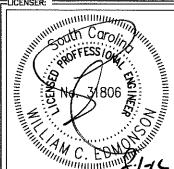
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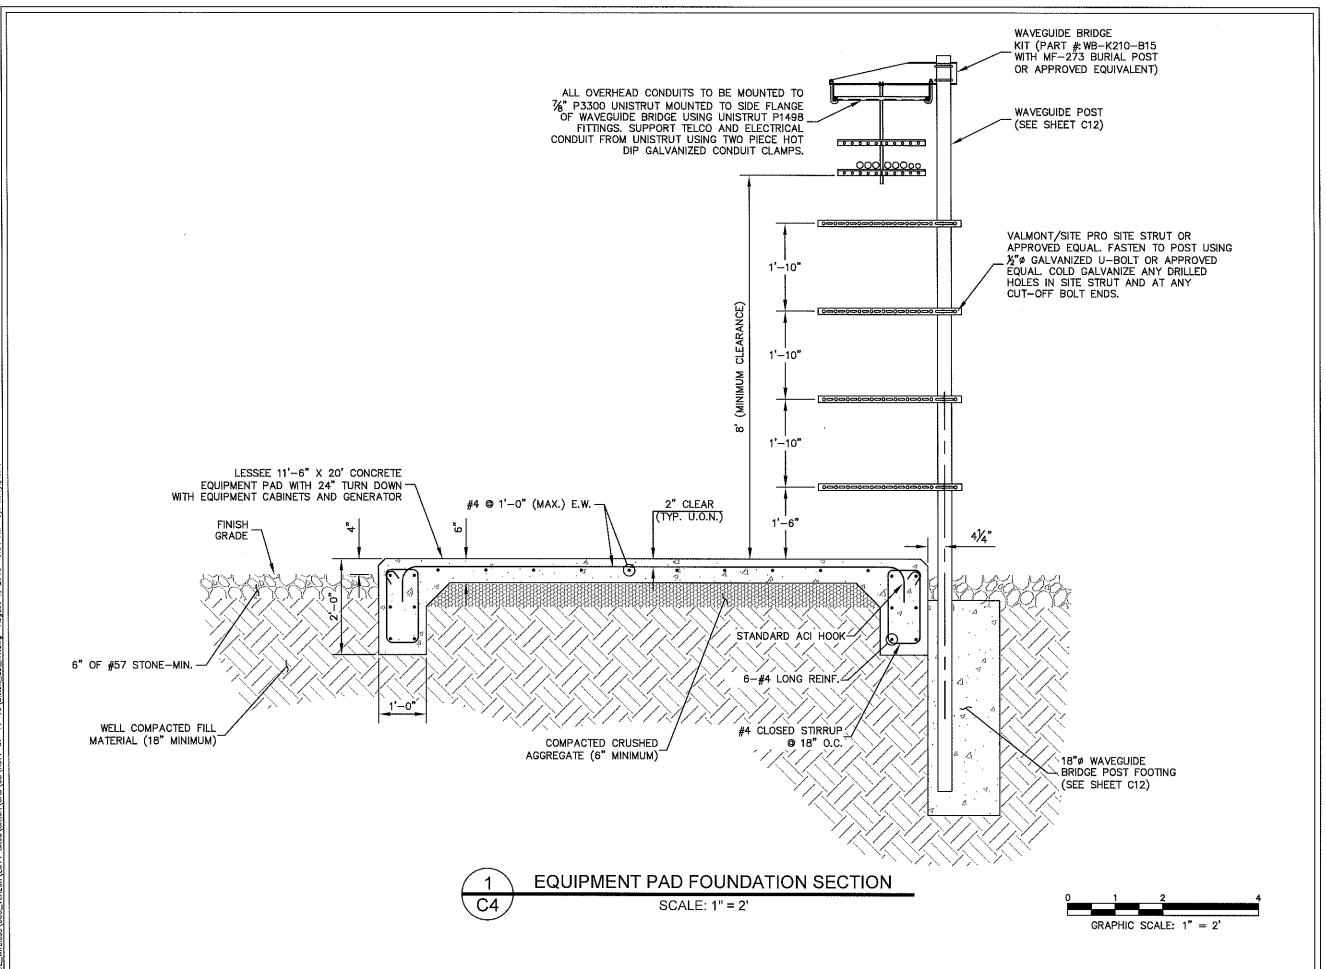
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(MLEY-HOR AND ASSOCIATES, INC. NO.C00166

DRAWN BY: CHK.: APV.: KRM WCE

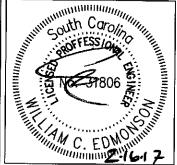

EQUIPMENT PAD LAYOUT



verizon/

8921 RESEARCH DRIVE CHARLOTTE, NORTH CAROLINA 28282

PROJECT INFORMATION:

VERIZON NAME: SITTON VERIZON No.: TBD

PRATER FARM ROAD SENECA, SC 28678 OCONEE COUNTY

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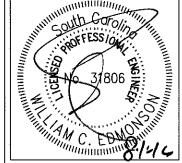
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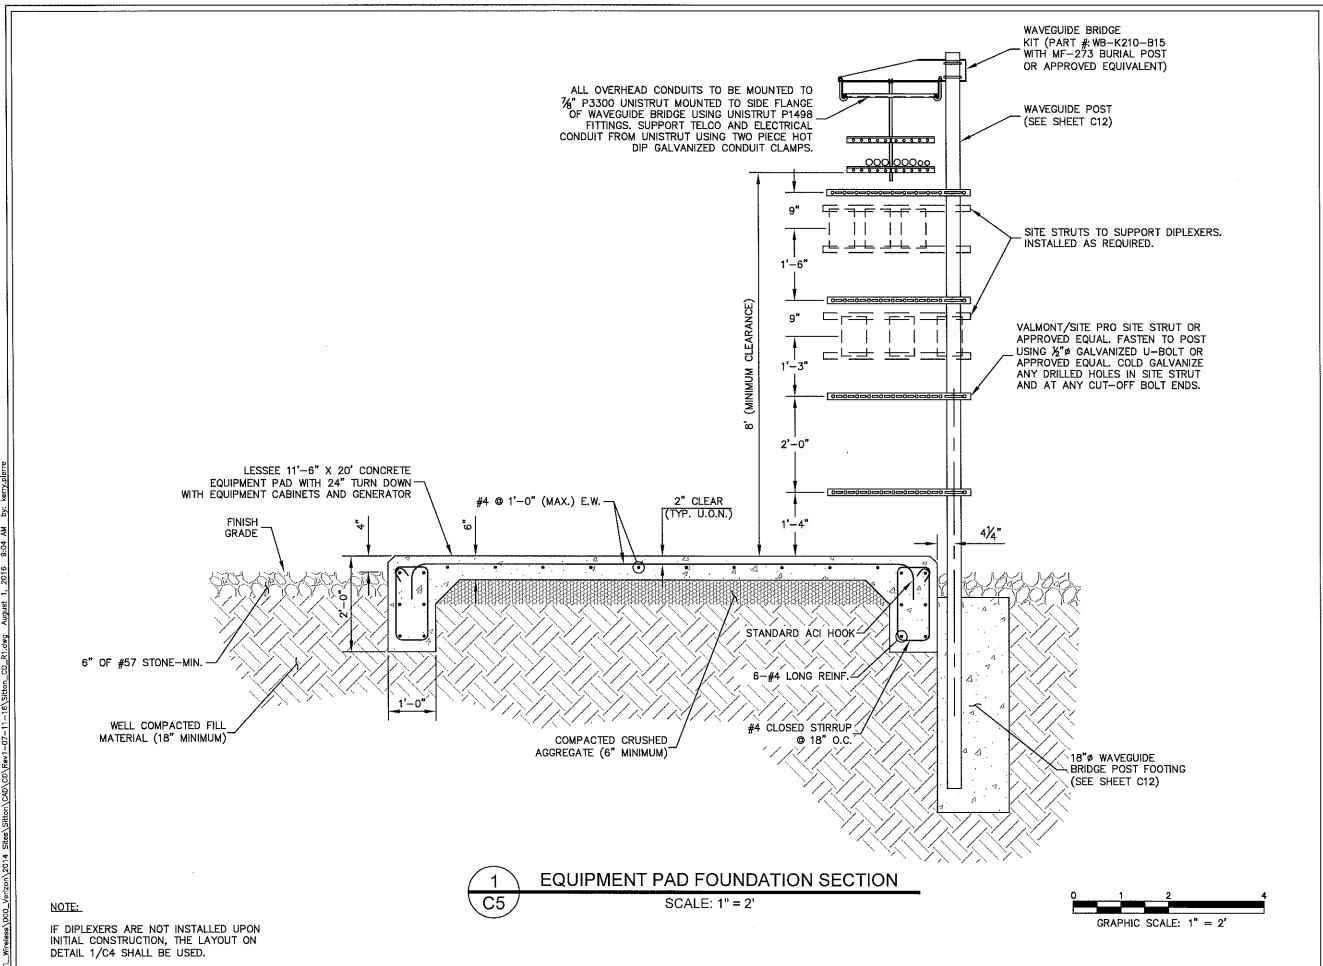
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EQUIPMENT PAD FOUDATION **SECTION DETAILS**

SHEET NUMBER:

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8921 RESEARCH DRIVE CHARLOTTE, NORTH CAROLINA 28282

PROJECT INFORMATION:

VERIZON NAME: SITTON VERIZON No.: TBD

PRATER FARM ROAD SENECA, SC 28678 OCONEE COUNTY

CURRENT ISSUE DATE:

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_CONSULTANT:=

Kimley » Horn

2 SUN COURT, SUITE 450
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PHONE: 770-825-0744
WWW.KIMLEY-HORN.COM
SC License C00166

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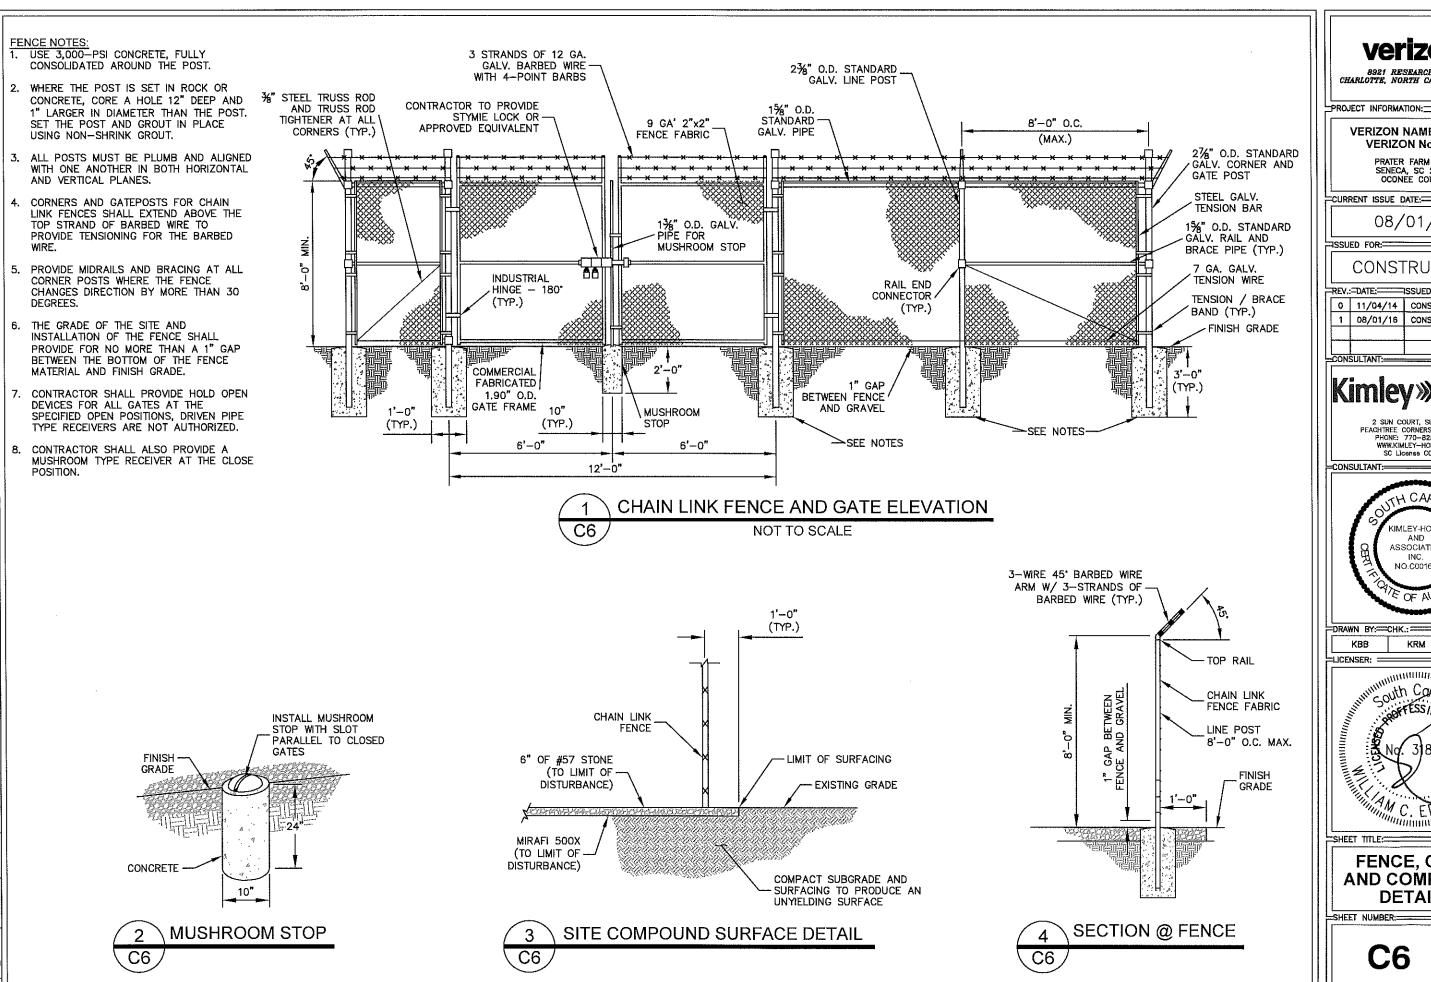
EQUIPMENT PAD FOUDATION SECTION DETAILS

SHEET NUMBER:—REVISION:—

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8921 RESEARCH DRIVE CHARLOTTE, NORTH CAROLINA 28282

VERIZON NAME: SITTON

VERIZON No.: TBD PRATER FARM ROAD SENECA, SC 28678 OCONEE COUNTY

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CONSULTANT:= KIMLEY-HOR AND ASSOCIATES, NO.C00166

DRAWN BY:-CHK.:-APV.; KBB KRM WCE LICENSER: =

South Coro SHEET TITLE:

FENCE, GATE, AND COMPOUND **DETAILS**

SHEET NUMBER: REVISION:


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NOTE: CURRENT DESIGN ANTICIPATES APPROXIMATELY 39,272± SQ. FT. (0.90 ACRES) OF CLEARING AND GRADING FOR THE PROPOSED PROJECT. IF ADDITIONAL CLEARING IS REQUIRED BEYOND WHAT IS SHOWN IN THE PLANS THE CONTRACTOR SHALL NOTIFY THE ENGINEER AND/OR PROJECT MANAGER, IF DURING THE BID WALK OR CONSTRUCTION IT IS DETERMINED THAT MORE THAN (1) ACRE OF LAND IS TO BE DISTURBED FOR CONSTRUCTION AN EROSION AND SEDIMENTATION CONTROL PLAN MUST BE FILED 30 DAYS PRIOR TO CONSTRUCTION.

- GRADING NOTES:
 1. THE CONTRACTOR SHALL CLEAR AND GRUB THE SITE AND PLACE, COMPACT, AND MOISTURE CONDITION ALL FILL PER THE PROJECT GEOTECHNICAL ENGINEERS SPECIFICATIONS, FILL MATERIAL SHALL BE APPROVED BY THE GEOTECHNICAL ENGINEER PRIOR TO PLACEMENT.
- ALL PROPOSED CONTOURS AND SPOT
- ELEVATIONS REFLECT FINISHED GRADES.
 CONTRACTOR SHALL BLEND EARTHWORK SMOOTHLY TO TRANSITION BACK TO EXISTING GRADE.
- PORTIONS OF THE SITE NOT SPECIFICALLY MENTIONED WITHIN THE GEOTECHNICAL REPORT SHALL BE COMPACTED TO 95 PERCENT OF THE MATERIALS MAXIMUM DRY DENSITY WITHIN 3 PERCENT OF OPTIMUM MOISTURE CONTENT.
- FILL SHALL BE PLACED IN MAXIMUM 8 INCH LOOSE LIFTS.
- UNDISTURBED AREAS WITHIN 30' INGRESS/EGRESS EASEMENT NOT NEEDED FOR UTILITY ROUTING TO BE LEFT UNDISTURBED.



verizon

8921 RESEARCH DRIVE CHARLOTTE, NORTH CAROLINA 28282

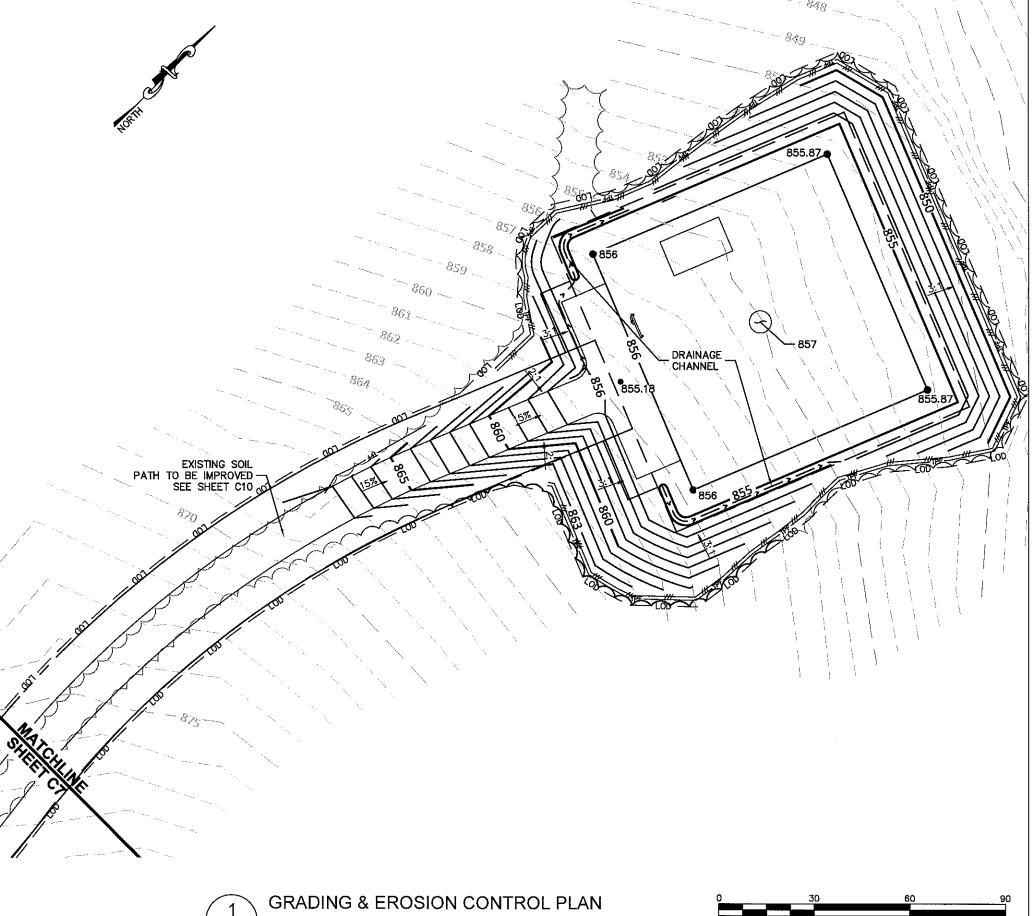PROJECT INFORMATION:

VERIZON NAME: SITTON VERIZON No.: TBD


PRATER FARM ROAD SENECA, SC 28678 OCONEE COUNTY

CURRENT ISSUE DATE:

08/01/16

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CONSTRUCTION

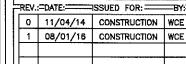


Kimley » Horn

2 SUN COURT, SUITE 450
PEACHTREE CORNERS, GA 30092
PHONE: 770-825-0744
WWW.KIMLEY-HORN.COM
SG License C00166

CONSULTANT:=



DRAWN BY: CHK.: APV.; KBB KRM WCE

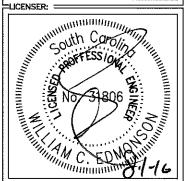

=SHEET TITLE:=


GRADING & EROSION CONTROL PLAN 1 OF 2

=SHEET NUMBER:=


GRAPHIC SCALE: 1" = 30'

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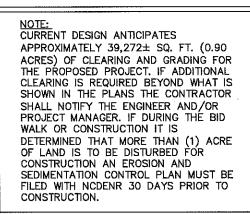
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PROPOSED SPOT ELEVATION ● XXX

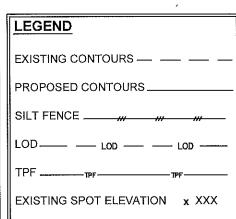



SCALE: 1" = 30'

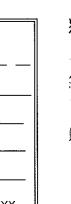

GRADING NOTES:

- 1. THE CONTRACTOR SHALL CLEAR AND GRUB THE SITE AND PLACE, COMPACT, AND MOISTURE CONDITION ALL FILL PER THE PROJECT GEOTECHNICAL ENGINEERS SPECIFICATIONS. FILL MATERIAL SHALL BE APPROVED BY THE GEOTECHNICAL ENGINEER PRIOR TO PLACEMENT.
- ALL PROPOSED CONTOURS AND SPOT ELEVATIONS REFLECT FINISHED GRADES.
- CONTRACTOR SHALL BLEND EARTHWORK SMOOTHLY TO TRANSITION BACK TO EXISTING GRADE.
- 4. PORTIONS OF THE SITE NOT SPECIFICALLY MENTIONED WITHIN THE GEOTECHNICAL REPORT SHALL BE COMPACTED TO 95 PERCENT OF THE MATERIALS MAXIMUM DRY DENSITY WITHIN 3 PERCENT OF OPTIMUM MOISTURE CONTENT.
- 5. FILL SHALL BE PLACED IN MAXIMUM 8 INCH LOOSE LIFTS.
- 6. UNDISTURBED AREAS WITHIN 30' INGRESS/EGRESS EASEMENT NOT NEEDED FOR UTILITY ROUTING TO BE LEFT UNDISTURBED.

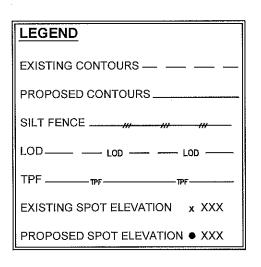

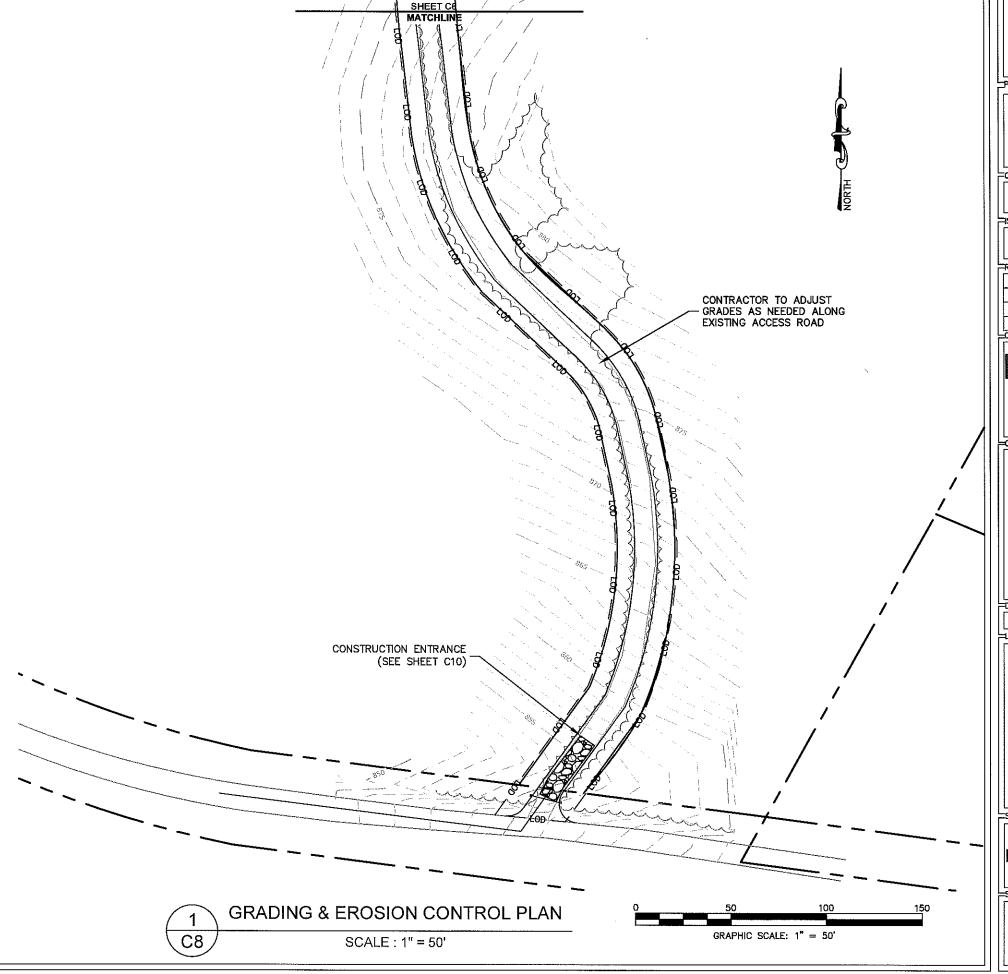

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8921 RESEARCH DRIVE CHARLOTTE, NORTH CAROLINA 28282

PROJECT INFORMATION:

VERIZON NAME: SITTON VERIZON No.: TBD

> PRATER FARM ROAD SENECA, SC 28678 OCONEE COUNTY

-CURRENT ISSUE DATE:----

08/01/16

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l	-	0	11/04/14	CONSTRUCTION	WCE
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CONSULTAN


Kimley » Horn

2 SUN COURT, SUITE 450
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SC License C00166

CONSULTANT:



DRAWN BY:=CHK.: APV.: WCE

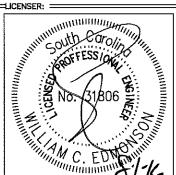

SHEET TITLE

GRADING & EROSION CONTROL PLAN 2 OF 2

SHEET NUMBER:


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018985125

soviant Kimley-Horn and Associates, Inc., 2016

EROSION CONTROL NOTES:

- 1. EROSION CONTROLS SHALL BE INSTALLED PRIOR TO CONSTRUCTION AND SHALL BE ADEQUATE TO MAINTAIN SEDIMENT ON SITE.
- 2. ALL EXCAVATED SOILS NOT NEEDED ON SITE FOR BACKFILL OPERATIONS SHALL BECOME PROPERTY OF THE CONTRACTOR AND SHALL BE TAKEN
 OFF SITE AND LEGALLY DISPOSED
- SOIL REMAINING ON SITE SHALL HAVE SILT FENCE TIGHTLY PLACED AROUND THE ENTIRE CIRCUMFERENCE OF THE PILE.
- 4. PROVIDE EROSION CONTROLS AS NECESSARY TO PREVENT EXISTING SOILS FROM DRAINING OFF SITE OR INTO EXISTING DRAINAGE STRUCTURES.
- 5. ERECTION OF EROSION CONTROLS SHALL BE IN ACCORDANCE WITH STATE AND LOCAL EROSION CONTROL REGULATIONS.



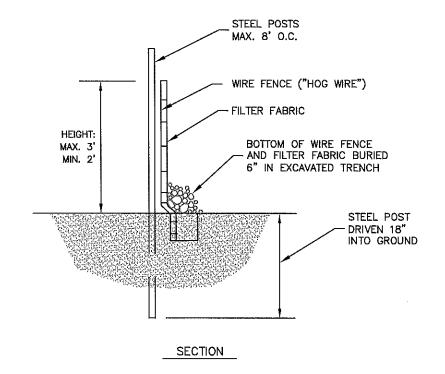

SEEDING SCHEDULE FOR WINTER / SPRING **CONSTRUCTION ACTIVITIES**

SEEDING MIXTURE

Species Rate (lb/acre) Rye (grain) 120 Annual lespedeza (Kobe in

Piedmont and Coastal Plain, Korean in Mountains)

Omit annual lespedeza when duration of temporary cover is not to extend beyond June.

SEEDING DATES

Mountains-- Above 2500 ft: Feb 15 - May 15 Below 2500 ft.: feb. 1 - May 1 Piedmont--Jan. 1 - May 1 Coastal Plain--Dec. 1 - Apr. 15

SOIL AMENDMENTS

Follow recommendations of soil tests or apply 2,000 lb/acre ground agricultural limestone and 750 lb/acre 10-10-10 fertilizer.

MULCH

Apply 4,000 lb/acre straw. Anchor straw by tacking with asphalt, netting, or a mulch anchoring tool. A disk with blades set nearly straight can be used as a mulch anchoring tool.

MAINTENANCE

Refertilize if growth is not fully adequate. Reseed, refertilize and mulch immediately following erosion or other

SEEDING SCHEDULE FOR SUMMER **CONSTRUCTION ACTIVITIES**

SEEDING MIXTURE

Species

Rate (lb/acre) 40-80 (1-2 lb/1,000

sq. ft.)

Common Bermudagrass

SEEDING DATES

Coastal Plain--Apr. 1 - July Piedmont--Apr. 15 - June 30


Apply lime and fertilizer according to soil tests, or apply 3,000 lb/acre ground agricultural limestone and 500 lb/acre 10-10-10 fertilizer.

MULCH

Use jute, excelsior matting, or other effective channel lining material to cover the bottom of channels and ditches. The lining should extend above the highest calculated depth of flow. On channel side slopes above this height, and in drainages not requiring temporary lining, apply 4,000 lb/acre grain straw and anchor straw by stapling netting over the top.

MAINTENANCE

A minimum of 3 weeks is required for establishment. inspect and repair mulch frequently. Refertilize the following Apr. with 50 lb/acre nitrogen.

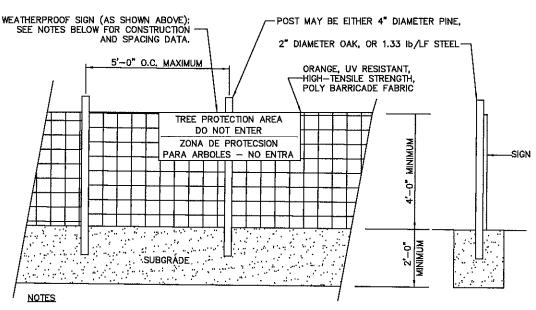

INSTALL TREE PROTECTION FENCE AND SIGNAGE PRIOR TO CALLING FOR SITE INSPECTION. MAINTAIN TREE PROTECTION FENCE THROUGHOUT DURATION OF PROJECT. ADDITIONAL SIGNS MAY BE REQUIRED BASED ON ACTUAL FIELD CONDITIONS.

> TREE PROTECTION FENCE NOT TO SCALE

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8921 RESEARCH DRIVE CHARLOTTE, NORTH CAROLINA 28262

PROJECT INFORMATION:

VERIZON NAME: SITTON VERIZON No.: TBD

PRATER FARM ROAD SENECA, SC 28678 OCONEE COUNTY

CURRENT ISSUE DATE:

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CONSTRUCTION


REV.:-DATE:---SSUED FOR:-0 11/04/14 CONSTRUCTION 1 08/01/16 CONSTRUCTION WCE

Kimley Horn

2 SUN COURT, SUITE 450 PEACHTREE CORNERS, GA 30092 PHONE: 770-B25-0744 WWW.KIMLEY-HORN.COM SC License C00166

=CONSULTANT:= CARO HI KIMI EY-HOR AND ASSOCIATES, INC. NO.C00166

DRAWN BY:-CHK.:-=APV.:= KRM KBB WCE

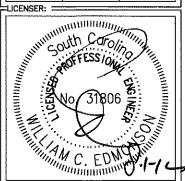


GRADING & EROSION CONTROL DETAILS

SHEET NUMBER:

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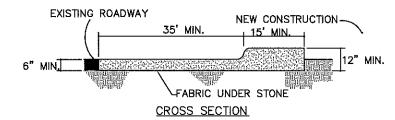
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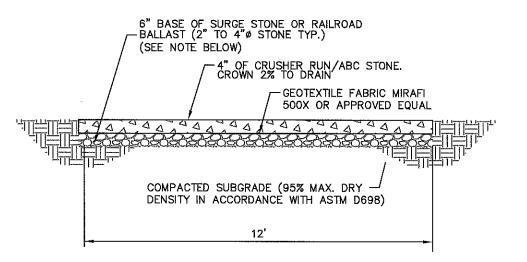
PUT SILT FENCE OR TREE PROTECTION FENCE UP TO ENSURE CONSTRUCTION ENTRANCE IS USED.

2. IF CONSTRUCTION ON THE SITES ARE SUCH THAT THE MUD IS NOT REMOVED BY THE VEHICLE TRAVEL-ING OVER THE STONE, THEN THE TIRES OF THE VEHICLES MUST BE WASHED BEFORE ENTERING THE PUBLIC ROAD.

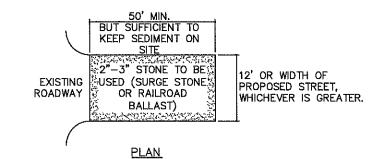3. IF A PROJECT CONTINUES TO PULL MUD AND DEBRIS ON TO THE PUBLIC ROAD, THE GOVERNING AUTHORITY WILL CLEAN THE AREA AND INVOICE THE FINANCIALLY RESPONSIBLE PERSON AS INDICATED ON THE FINANCIAL RESPONSIBILITY FORM.







NOTE:

IF DETERMINED NECESSARY DURING GRADING AND CONSTRUCTION OF THE ACCESS ROAD BY THE VERIZON WIRELESS PROJECT MANAGER, THE CONTRACTOR SHALL INSTALL 6" BASE OF SURGE STONE OR RAILROAD BALLAST (2" TO 4" STONE TYP.)





8921 RESEARCH DRIVE CHARLOTTE, NORTH CAROLINA 28282

PROJECT INFORMATION:

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PRATER FARM ROAD SENECA, SC 28678 OCONEE COUNTY

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1	08/01/16	CONSTRUCTION	WCE


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CONSULTANT:



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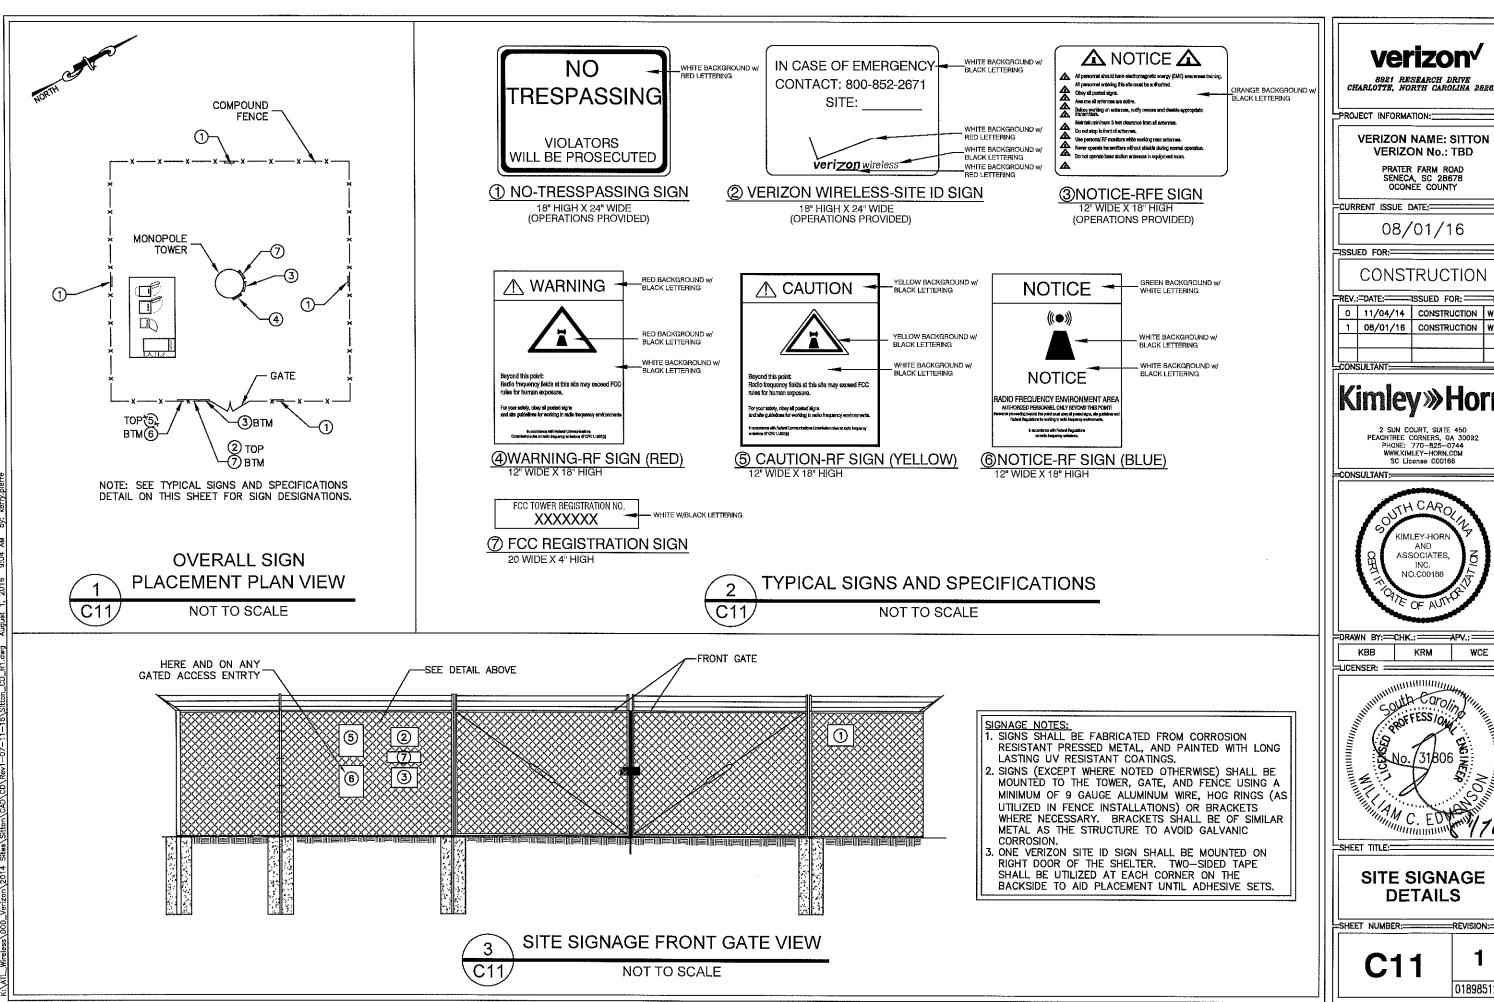
=SHEET TITLE:=

ACCESS ROAD DETAILS

SHEET NUMBER:

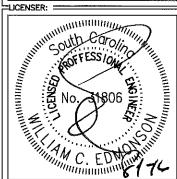018985125

==REVISION:=



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8921 RESEARCH DRIVE CHARLOTTE, NORTH CAROLINA 28262

PROJECT INFORMATION:

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PRATER FARM ROAD SENECA, SC 28678 OCONEE COUNTY

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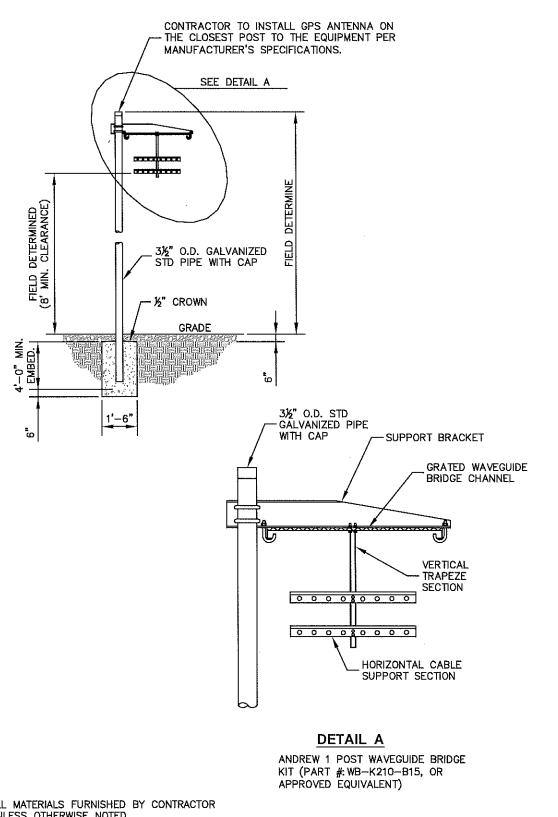
Kimley Horn

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=DRAWN BY:==CHK.:==APV.:=

SITE SIGNAGE **DETAILS**



WAVEGUIDE BRIDGE DETAIL

NOT TO SCALE

CONTRACTOR TO INSTALL GPS ANTENNA ON THE CLOSEST POST TO THE EQUIPMENT PER MANUFACTURER'S SPECIFICATIONS. SEE DETAIL B 3111 3½" O.D. GALVANIZED STD PIPE WITH CAP -½" CROWN GRADE 1'-6" SUPPORT BRACKET GRATED WAVEGUIDE BRIDGE CHANNEL 3½" O.D. STD GALVANIZED PIPE-TRAPEZE WITH CAP SECTION 0 0 0 0 8 0 0 0 0 000080000 HORIZONTAL CABLE SUPPORT SECTION

NOTE:

ALL MATERIALS FURNISHED BY CONTRACTOR UNLESS OTHERWISE NOTED.

DETAIL B ANDREW 2 POST WAVEGUIDE BRIDGE KIT (PART #: WB-K410-B15, OR APPROVED EQUIVALENT)

WAVEGUIDE BRIDGE DETAIL (ALTERNATIVE DESIGN WITH 2 PIPE COLUMNS)

NOT TO SCALE

2 SUN COURT, SUITE 450
PEACHTREE CORNERS, GA 30092
PHONE: 770-825-0744
WWW.KIMLEY-HORN.COM
SC License C00166

KIMLEY-HOR AND ASSOCIATES, INC. NO.C00166

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VERIZON NAME: SITTON VERIZON No.: TBD

PRATER FARM ROAD SENECA, SC 28678 OCONEE COUNTY

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1 08/01/16 CONSTRUCTION WCE

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0 11/04/14 CONSTRUCTION

PROJECT INFORMATION:

CURRENT ISSUE DATE:

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CONSULTANT:-

=DRAWN BY:==CHK.:= KRM KBB WCE

=LICENSER: ===

WAVEGUIDE BRIDGE DETAILS


=SHEET NUMBER:====REVISION:=

018985125

1. ALL MATERIALS FURNISHED BY CONTRACTOR UNLESS OTHERWISE NOTED.

NOTE:



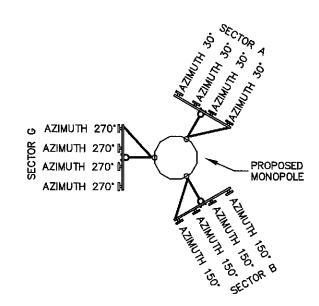

ANTENNA ORIENTATION PLAN

(NOT TO SCALE, FOR ILLUSTRATIVE PURPOSES ONLY, SEE STRUCTURAL ANALYSIS BY OTHERS TO CONFIRM ANTENNA MOUNT TYPE)

ANITENINA	AZIMUTH	MECHANICAL	LIOTAGED	ANTENNA*		co	MPOSI	TION CABL	ES.
	IN DEGREES	DOWN TILT	LICENSED FREQUENCY	(QTY) MAKE/MODEL	REMOTE RADIO UNIT	LENGTH		COAX	TOTAL
	DEGREES					LENGIA	QTY	SIZE	HYBRID
	30*	0*	850	_	-	404'±	-	_	
SECTOR	30°	0,	1900	(0) ANDREW/SBNHH-1D65C	RRUS32	404'±	_	-	
A	30.	0,	2100	(0) ANDREW/SBNHH-1D65C	RRUS32	404'±	_	_	1 1
	30°	0,	700	(2) ANDREW/SBNHH-1D65C	RRUSB13/A2	404'±	2	1-5/8"ø	
·	1501	0,	850	-		404'±	_		1
SECTOR	150*	0.	1900	(0) ANDREW/SBNHH-1D65C	RRUS32	404'±		_	1 .
₿	1501	0.	2100	(0) ANDREW/SBNHH-1D65C	RRUS32	404'±		_	2
	150	0.	700	(2) ANDREW/SBNHH-1D65C	RRUSB13/A2	404'±	2	1-5/8"ø	1
	270*	0,	850	-	-	404'±	-	_	
SECTOR	270*	0.	1900	(0) ANDREW/SBNHH-1D65C	RRUS32	404'±	_	_	
G	270*	0,	2100	(0) ANDREW/SBNHH-1D65C	RRUS32	404'±	-	 	
	270°	0.	700	(2) ANDREW/SBNHH-1D65C	RRUSB13/A2	404'±	2	1-5/8"ø	1

* CONTRACTOR TO INSTALL ANY RAYCAP BOXES AS NECESSARY. FOR TOWER DESIGN, ANALYSIS, OR LEASING PURPOSES, SIX (6) FUTURE 1%" COAX CABLES SHALL BE CONSIDERED. VERIFY WITH VERIZON WIRELESS PROJECT MANAGER PRIOR TO CONSTRUCTION.

1. ALL INFORMATION ON THIS PAGE IS PROVIDED BY VERIZON WIRELESS AND/OR OTHERS AND IS SHOWN FOR ILLUSTRATIVE PURPOSES ONLY. CONTRACTOR SHALL CONTACT THE VERIZON WIRELESS CONSTRUCTION MANAGER PRIOR TO CONSTRUCTION FOR ALL DETAILED ANTENNA, AND COAX CABLE INFORMATION.

2. REFER TO STRUCTURAL ANALYSIS BY TOWER OWNER FOR ANALYSIS OF PROPOSED TOWER.

3. IT IS UNDERSTOOD THAT KIMLEY-HORN MAKES NO WARRANTY, EITHER EXPRESSED OR IMPLIED, FINDINGS, DESIGNS. RECOMMENDATIONS, SPECIFICATIONS, OPINION, OR PROFESSIONAL ADVICE RELATING TO THE STRUCTURAL ADEQUACY OF THE PROPOSED TOWER OR ATTACHMENT OF ANTENNAS OR OTHER APPURTENANCES.

LINK SECURITY FENCE

PROPOSED CHAIN

MONOPOLE TOWER ELEVATION - NORTHEAST VIEW (FACING SOUTHWEST)

C13

1. ALL PROPOSED ATTACHMENTS TO TOWER BASED ON TOWER DESIGN DRAWINGS BY OTHERS (SEE GENERAL NOTE 1.07, SHEET N1).

- 2. THE TOWER ELEVATION SHOWN IS FOR REFERENCE ONLY.
- 3. COAX CABLE LENGTHS ARE APPROXIMATE. CONTRACTOR TO VERIFY CORRECT LENGTH IN FIELD AT TIME OF CONSTRUCTION.
- 4. PROPOSED TOWER WILL BE GALVANIZED STEEL-GRAY IN COLOR.
- 5. PROPOSED ANTENNAS WILL BE LIGHT GRAY IN COLOR.

TOP OF LIGHTNING ROD EL,174' A.G.L.

PROPOSED LESSEE ANTENNAS

© EL.165' A.G.L.

PROPOSED 165' MONOPOLE TOWER

PROJECT INFORMATION: **VERIZON NAME: SITTON**

> **VERIZON No.: TBD** PRATER FARM ROAD SENECA, SC 28678 OCONEE COUNTY

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8921 RESEARCH DRIVE CHARLOTTE, NORTH CAROLINA 28262

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CONSULTANT:=



DRAWN BY:--CHK.:---KBB KRM WCE

LICENSER: =

LESSEE 11'-6" X 20' CONCRETE EQUIPMENT PAD WITH 24" TURNDOWN

W/EQUIPMENT CABINETS AND

GÉNERATOR

FOR ILLUSTRATIVE **PURPOSES ONLY-**NO SIGNATURE **REQUIRED**

SHEET TITLE:

ANTENNA AND TOWER ELEVATION **DETAILS**

SHEET NUMBER:


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NOTES:

TOP OF TOWER

EL.165' A.G.L.

NOT TO SCALE

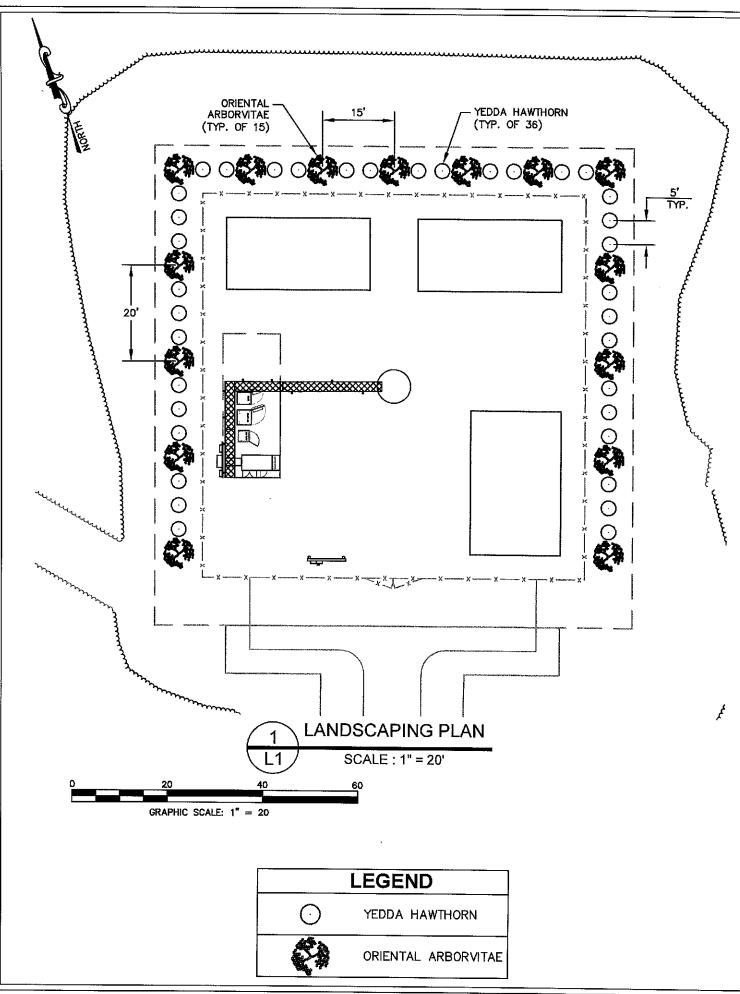

GENERAL LANDSCAPE NOTES:

- THE LANDSCAPE CONTRACTOR SHALL BE RESPONSIBLE FOR COORDINATION OF HIS WORK WITH THAT OF ALL OTHER
 CONTRACTORS. THIS PLAN DOES NOT GUARANTEE THE EXISTENCE OR NON-EXISTENCE OF ANY UTILITIES. PRIOR TO
 COMMENCEMENT OF ANY WORK, THE LANDSCAPE CONTRACTOR SHALL VERIFY THE LOCATIONS OF ALL ABOVE GROUND
 AND UNDERGROUND UTILITIES.
- THE QUALITY AND SIZE OF ALL PLANT MATERIAL SHALL CONFORM TO THE MOST CURRENT STANDARDS AS SET FORTH IN ANSI Z60.180 - AMERICAN STANDARD FOR NURSERY STOCK.
- 3. ALL DISTURBED AREAS NOT COVERED BY HARDSCAPE OR PLANT MATERIALS SHALL BE COVERED WITH SEED AND STRAW.
- 4. PLANT SUBSTITUTION MAY BE PERMITTED ONLY AFTER PROOF THAT SPECIFIED PLANTS ARE UNAVAILABLE AND THE REQUEST HAS BEEN SUBMITTED TO THE OWNER OR LANDSCAPE ARCHITECT. THE CONTRACTOR SHALL PROVIDE THE NEAREST EQUIVALENT OBTAINABLE SIZE AND VARIETY OF THE PLANT HAVING THE SAME ESSENTIAL CHARACTERISTICS AS THE PLANT SPECIFIED
- MINOR PLANT LOCATION ADJUSTMENTS MAY BE MADE IN THE FIELD TO ENSURE ACCESS TO UTILITY JUNCTION BOXES, FREE SITE LIGHTING OF FUTURE TREE CANOPY INTERFERENCE AND ALLOW UNINHIBITED PEDESTRIAN / VEHICULAR CIRCULATION ON ALL PAVEMENTS OR FOUNDATIONS.
- 5. ALL SHRUB MASSES OF TWO OR MORE SHALL BE EDGED INTO A PLANTING BED AND MULCHED PER DETAIL. ALL INDIVIDUAL TREES AND SHRUBS SHALL HAVE A MULCH SAUCER EQUAL IN DIAMETER TO THE PLANTING PIT DIAMETER AND SHALL BE MULCHED AS SHOWN ON THE DETAILS. UNLESS OTHERWISE INDICATED, ALL BED EDGES SHALL BE A DEEP CUT CLEAN SPADE EDGE.
- 7. THE CONTRACTOR SHALL VERIFY THAT EACH TREE OR SHRUB PIT WILL DRAIN BEFORE INSTALLING PLANT MATERIAL. HE SHALL FILL THE HOLE WITH SIX INCHES (6") OF WATER THAT SHOULD PERCOLATE OUT WITHIN TWENTY-FOUR HOURS. SHOULD ANY AREA NOT DRAIN PROPERLY, A PERFORATED DRAIN LINE SHALL BE INSTALLED, OR THE PLANTS RELOCATED.
- 8. THE CONTRACTOR SHALL NOTIFY THE OWNER IMMEDIATELY IF HE ENCOUNTERS ANY UNSUITABLE SURFACE OR SUBSURFACE DRAINAGE CONDITIONS, SOIL DEPTH, LATENT SOILS, HARD PAN, UTILITY LINES, OR OTHER CONDITIONS THAT WILL JEOPARDIZE THE HEALTH AND VIGOR OF THE PLANTS. SHOULD THE CONTRACTOR NOT NOTIFY THE OWNER OF A PROBLEM AREA, HE WARRANTS THAT THE AREAS ARE SUITABLE FOR PROPER GROWTH AND DEVELOPMENT OF ALL PLANTS INSTALLED.
- THE CONTRACTOR SHOULD VERIFY LANDSCAPING/TREE PLANTING LOCATIONS WITH THE PUBLIC UTILITIES DEPARTMENT TO AVOID CONFLICTS WITH WATER, SEWER, AND GAS LINES.
- 10. PLANTS SHALL BE SO TRAINED IN DEVELOPMENT AND APPEARANCE AS TO BE UNQUESTIONABLE SUPERIOR IN FORM, COMPACTNESS AND SYMMETRY. THEY SHALL BE SOUND, HEALTHY, VIGOROUS, WELL BRANCHED AND DENSELY FOLIATED WHEN IN LEAF, AND FREE OF DISEASE AND INSECT ADULT EGGS, PUPAE OR LARVAE. THEY SHALL HAVE HEALTHY, WELL-DEVELOPED ROOT SYSTEMS AND SHALL BE FREE FROM PHYSICAL DAMAGE OR OTHER CONDITIONS THAT WOULD PREVENT THRIVING GROWTH.
- 11. THERE SHALL BE NO CIRCLING OR GIRDLING ROOTS. CIRCLING ROOTS SHOULD BE CUT IN AT LEAST ONE PLACE.
- 12. THERE SHOULD BE ONE DOMINANT LEADER TO THE TOP OF THE TREE WITH THE LARGEST BRANCHES SPACED AT LEAST 6 INCHES APART. THERE CAN BE TWO LEADERS IN THE TOP 10% OF THE TREE IF IT IS OTHERWISE OF GOOD QUALITY.
- 13. THE TREE CANOPY SHOULD BE SYMMETRICAL AND FREE OF LARGE VOIDS. CLEAR TRUNK SHOULD BE NO MORE THAN 40% OF TREE HEIGHT UNLESS OTHERWISE SPECIFIED IN THE PLANTING SPECIFICATIONS. CLEAR TRUNK SHALL BE OF SUFFICIENT HEIGHT TO CLEAR SURROUNDING USES THAT MAY BE IMPACTED BY THE FUTURE GROWTH OF THE TREE.
- 14. OPEN TRUNK AND BRANCH WOUNDS SHALL BE LESS THAN 10% OF THE CIRCUMFERENCE AT THE WOUND AND NO MORE THAN 2 INCHES TALL. PROPERLY MADE PRUNING CUTS ARE NOT CONSIDERED OPEN TRUNK WOUNDS. THERE SHOULD BE NO CONKS OR BLEEDING, AND THERE SHOULD BE NO SIGNS OF INSECTS OR DISEASE ON MORE THAN 5% OF THE TREE.
- 15. IF ANY OF THE ABOVE CONDITIONS ARE NOT MET, TREES MAY BE REJECTED.
- TREE PROTECTION DEVICES MUST BE INSTALLED AND INSPECTED PRIOR TO ANY CLEARING, GRUBBING, OR GRADING OF THE SITE BY THE LOCAL ARBORIST.

		Р	LANTING LIST	Γ		,	
SYM./KEY	QTY.	BOTANICAL	COMMON		SPECIF	ICATION	
31W./KE1	QII.	NAME	NAME	PLANTING HEIGHT	ROOT	CALIPER/ SIZE	SPACING
YH	36	PHAPHIOLEPIS UMBELLATA	YEDDA HAWTHORN	5'-6'	В&В	5/8"	5' O.C.
OA	15	THUJA ORENTALIS	ORIENTAL ARBORVITAE	10'-12'	B&B	1 3/4"	SEE PLAN

verizon/

8921 RESEARCH DRIVE CHARLOTTE, NORTH CAROLINA 28262

PROJECT INFORMATION:

VERIZON NAME: SITTON VERIZON No.: TBD

PRATER FARM ROAD SENECA, SC 28678 OCONEE COUNTY

CURRENT ISSUE DATE:

02/16/17

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CONSTRUCTION

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0 02/16/17 CONSTRUCTION WCE

CONSULTAN

Kimley »Horn


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CONSULTANT:



DRAWN BY:=CHK.:=APV.:=

KBB KRM WCE

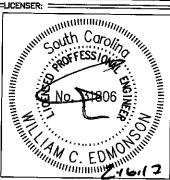

SHEET TILE:

LANDSCAPING PLAN AND NOTES

SHEET NUMBER:-----REVISION:-

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BASIC SERVICE ROUTING NOTES AND SPECIFICATIONS:

- ALE BLECHRICAL WORK SHALL COMPLY WITH NEC, STATE, AND LOCAL CODES, ALL DI FOTRICAL DEVICES, MATERIALS, AND SERVICE EQUIPMENT SHALL BE CABELLISTED BY AN APPROVED THEIR PARTY TESTING ACTION.
- 2. CONTRACTOR SHALL OBTAIN OWNER/TENANT SPECIFICATIONS AND REMEMBED FOR ADDITIONAL OFFAILS AND REQUIREMENTS THAT MAY NOT BE SHOWN IN LICEL. DRAWINGS, CONTRACTOR SHALL COMPLY WITH ANY ADDITIONAL OWNER/TENANT. SPECIFICATIONS AND REQUIREMENTS.
- CONTRACTOR SHALL COORDINATE WITH THE ELECTRIC UTILL Y FOR THE EXACT TRANSFORZER LOCATION, MICHOSING REQUIREMENTS, AND SERVICE FOUTING. CONTRACTOR SHALL COORDINATE WITH THE TELEPHONE UTILITY FOR THE EXACT TELEPHONE REQUIREMENTS AND SERVICE ROUTING.
- PRIOR TO PURCHASING COURMENT, THE CONTRACTOR SHALL CONTACT THE DI FOTRIO ITTUTY AND OBTAIN IN WRITING THE WAXIYUM AVAILABLE. AULT CURRENT AT IT IS UTILL Y SERVICE POINT, PROMDEMAX AFOR SIGNAGE AR. REQUIRED PER NEO 110-24. THE CONTRACTOR SHALL ENSURE ALL ELLCTRICAL. EQUIPMEN. C. WOUTH BRUCKETS, DISCONNECTS, PURES, AND PANELBOARDS HAVE A FAULT OURREST INTERRUPTING HATING GREATER. II AN THE AVAILABLE FAULT CURRENT, IN NO CASE STALL THE FAULT CURRENT INTERPUPTING RATING. BE LESS THAN 10,000 AMPS.
- CONTRACTOR TO PROVIDE 200 LB FEST POLYBRITYLISNE PULL CORDS SCOURLLY PASTERED AT LACTIOND OF POWER AND THE CO CONDUCT NOTHINGS. INNERDIGTS PROVIDE CAPS ON EADS OF UNUSED CONDUIT.
- CONTRACTOR TO PROVIDE A REBAR MARKER MALL AT LEAST 2 FLET DXF00ED. ABOVE GRADE AND PAINTED DRIGHT ORANGE TO INDICATE LOCATION OF CONDUIT CAPSED BELOW GRADE.
- PRICE TO TREVOHING CONTRACTOR SHALL LOCATE ALL EXISTING UNDERGROUND UTILITIES CONTRACTOR SHALL SEPAIR AT CONTRACTOR'S EXPENSE ANY DAMAGE TO EXISTING UNLINES.
- 8. CONTRACTOR TO VERIFY EXACT ROLLING OF FOWER AND TELECO CONDUIT WITH LOCAL ZILLINGS AND OWNER/TENANT, ENSURE ALL CONDUCT STUB-LIPS. ACCOMMODATE EQUIPMENT REQUIREMENTS.
- UNDERGROUND CONDUITS STIALL BE SCHLDULL AS EVOLUMICSS NOTED. OTHERWISE, USE SCHEDULE SCIEVE CONDUIT UNDER BOADS AND IN AREAS. ABOVE GRADE HIAT EXPOSED AND SUBJECT TO DAMAGE, MANUFACTURED PENDE SHALL HAVE A MINIMUM SADIUS OF 24 INCHES.
- 10. CONDUCT ROVERSHALL HAVE A CONTINUOUS SLOPE DOWNWARD AND AWAY FROM THE EQUIPMENT TO ALLOW WATER TO FLOW AWAY FROM THE EQUIPMENT AND SHELTER EXCAVATE TRENCHES ALONG STRAIGHT LINES PRIOR TO INSTALLING CONDUIT TO ACCOMMODATE ADJUSTING THEIR ITVATION AS REFORD.
- 31. CONDESTIBILITIES EQUIPMENT SHALL BE SEALED WITH A SEALANT THAT IS: IDENT FIFE FOR IDEE WITH THE CABLESCONDUCTOR INSULATION, STIGLOWS, LITT.
- 12. THE OWNER SHALL PURNISH AND THE CONTRACTOR SHALL INSTAUL ADDITIONAL SIGNAGE TO DELOCATED AT THE COMPO., VD FENCE, CONTRACTOR SHALL COORDINATE VALHOWNER/TENANT CONSTRUCTION MANAGER FOR PEACEMENT OF SIGNAGE.
- UPON COMPLETION OF CONSTRUCTION, CONTRACTOR IS RESPONSIBLE FOR REPAIRING ANY DAMAGE CAUSED BY CONSTRUCTION ACTIVITIES TO THE LANDSCAPING AFFA
- 14 CONTRACTOR ENSURE A MINIMUM 3 WORKING CLEARANCE IN FRONT OF BLECTRICAL SQL PMENT PER NEC.
- 15. THE CONTINUE FOR SHALL ADDIES GRAVED PHENOLICI AFEL TO THE ESONT OF PANEL INPORTANT READS, MAXIMUM DRAW OF ALL RECTIFIERS PLUS ALL. AND LIARY EQUIPMENT SHALL NOT EXCEED 30KW (F MORE THAN 30KW OF FOWER IS REQUIRED. THE EXISTING ROKWIGENERATION WILL NEED TO UL-1716 (ADE)
- 18. CON WASTOR TO PROVIDE PULL BOXES AS NEEDED TO ENSURE NO DREATER. THAN 850 DEGREES OF BUNDS BUTWALIN PULL POINTS IN CONDUCT RUNS,
- 17. GON RACTOR COORDINATE WITH LOCAL UTILITY COMPANY FOR SERVICE TO THIS COINT
- 18. COORDINATE FXACT ROUTING, INSIDE OR CUTSIDE FENCE, WHILL CANER-TENANT CONSTRUCTION VANAGER, DOUTE CONDUIT WITHIN STOF FENCE.
- 19. CONDUITS CHOLLD BE ROUTED OVERHEAD ON DE BRIDGE EXCEPT CENERATOR. CONDUITS RUN ON CABLE I RAY YOUNTED TO CONCIUTE PAD.

GROUNDING NOTES AND SPECIFICATIONS:

- THE GROUND RING SHALL COMBIST OF \$2 AWG RADE SOLID TINNED COPIED. (STC) CONDUCTOR, UNLESS NOTED OF ERROSE BURIED AT 30' BSLOW. FINISHED GRADE (OR BETOW FROST LINE) I GOATE (4" WINDUM AND 98" MAXIMUM FROM EQUIPMENT PAD AND FROM LOWER FOUNDATION, ALL CONNECTIONS SHALL BE MADE USING A PARALLEL TYPE EXOTHERMIC WELL). LIVLESSING BE OTHERWISE.
- 2. INSTALL GROUND RODS AS SHOWN AND AS REQUIRED, GROUND RODS TO BE COPPER OLAD STEEL ISS! DIAMETER AND TOFF IN LENGTH, SPACING DETWEEN GROUND ROUS SHALL BE 10-1 MINW LM AND 15-1 MAXIMUM, TOP OF GROUND BOD TO BE 32' MINIMUM BELOW GRADE (OR RELOW PROST LINE), DOND TOP OF GROUND ROB TO GROUND WIRE WITH EXOTRESMIC WELD, DO NOT EXOTHERMICALLY WELD ANYTHING TO GROUPD GOD EXCTIT GROUND WIND. WHICH PASSES OVER TOP OF GROUND ROD (CLAWFED CONNECTIONS TO GROUND ROD FER TOWER MASUFACTURERS DETAILS ARE ACCUADABLE).
- 5. EQUIPMENT CROUND BING SHALL HAVE A MINIMUM OF 4 GROUND YOUS. INSTALLED AT THE CORNERS OF THE GROUND RING PLUS ADOIT ONAL ROBS AS 17, BOND FACH COMMSCOPE SPAZASY DAT (LIKY CABINE). O SHOUND RING SECURED TO COMPLY WITH THE STACING REQUIREMENTS, TOWER GROUND KING STALL HAVE A MINIMUM OF DISROUND RODS, EXCEPT USE 4 RODS AT A MONOPOLE TOWER
- 4. FOURTHAL GROUND RING AND TOWER GROUND RING SHALL BE BOADOD. TOGETHER WITH TWO #2 STO GROUND LEADS, TYP CALLY ONE ON EAGH SIDE
- 6 BOND TOWER TO TOWER ORGAND BING AT THEFE LOCATIONS WITH AS STO. GROUND LEAD, SELF SUPPORT TOWERS SI WELFMAR EACH LES BONDED TO GROUND RING, MONOPOLES AND GIVED TOWERS SHALL HAVE GROUND LEADS. A KLA, THEA CONTINUE TO SSOUND RING. EQUALLY SPACED AROUND TOWER, EXCITIENMICALLY WELD GROUND LEADS TO TOO DE BASE PLATES, DE ATTACH TO TOMER USING TOWER MANUFACTURED. PROVIDED DE AIL.
- 6. PROVIDE \$2 STC RADIALS FROM THE TOWER GROUND RING TO EACH FENCE. CORNER POST, RADIA: 8 SHALL HAVE GROUND RODS AS PER THE REQUIRED. SPACING, I LIGROUND ROUGH THE END OF EACH RADGESTALL BE 241 MAXIMUM FROM FENCE CORNER POST.
- 7. MINIMUM BEND RADIUS FOR 42 AWO GROUND WIRE IS 101, FXCFPT USE 241 FOR TOWAR GROUND RINGS AND EQUIPMENT FAD GROUND RINGS.
- GROUND AUTENIOR EXPOSED METAL COULDES, USE TWO HOLL LUGS FOR CONNECTION TO FLAT METAL SURFACES, USE ONLY STAIN, ESSISTEFI. PARDWARE ON ALL MESHANICAL CONNECTIONS, CLEAN ALL SURFACES YARD STRIP PAINTED SUSFACES) TO BASE BRIGHT METALIPS OR TO MAKING CROUND I POST CONNECTIONS, APPLY AVAILABILITY COMPOUND TO ALL CONNECTIONS, APPLY ZING BIGH PAINT (COLD CIALW) TO ALL EXOTHERVICIWELDS, AND TO ANY METAL 128. ANY FENCE POST WITHIN 6FLOUR A GROUNDLE METAL OBJECT SHALL BE EXPOSED BY CLEANING, STRIPPING, GRANDING, OUT TING OR DRILLING.
- PVC CONDUIT, CONDUIT SHALL BEGIN WITHIN \$41 OF ABOVE OROUND CONNECTION POINT, SHALL EXTEND 34' BELOW GRADE MINIMUM, AND SHALL U. FILLED WITH GEALANT AT ABOVE GROUND CONNECTION POINT, SECURE CONDUIT EVERY 24" ON VERTICAL BUNS AND EVERY 88" ELSEWHERE WITH WON METALUCINES.
- C. WHERE POSSIBLE, MOUNT TOGGS PAY 4 TOWER BOTTOM GROUND BARICK DEDICATED POST BELOW COAX DABLES COMING OFF TOWOR, WHORE NSTALLATION OF POST WOULD PUT TOWER BOTTOM GROUND BAR TOO FAR. FROM COAX GROUND KITS, OLAMPITOSCA-BOM TOWER BOTTOM GROUND DATE DIRECTLY TO TOWER STEEL (LIGUALLY DOCURS ON MONOPOLE TOWERS) AND FAND TO TOWER CRAINING WITH TWO 42 STO LEADS (LIGGED TO GROUND BAR AND EXOTHERY, CALLY MELDED TO GROUND RING.
- HI, AT EQUIPMENT PAD, SUSPEXO LOSSA WUST EXCENSOR GROUND BAR FROM LICE BRIDGE AND ISOLATE FROM ICE BRIDGE ROAD GROUND BAR TO FQUIPMENT GROUND RING WITH TWO VZ STO LEADS LUGGED TO GROUND BAR AND EXOTHERWICALLY MELDED TO GROUND RING, BUN LEADS DOWN NEASEST, CF. DRINGE FORT AND SECURE TO POST WITH NON-METALLIC HES EVERY 24 INCHES.
- 12 ALL ICE BRIDGE SECTIONS ARE TO BE JUMPERED TOGETHER WITH ₩ CARE EITHER BARE TINNED COPPER OF GREEN INSURATED STRAWFOR, KIZ BRIDGE SHALL BE GROUNDED AT SACHEND WITH \$2,810 WIRE LUGSED TO ICE BRIDGE AND EXOTHERMICALLY WITHDEN TO DEPER PORTION OF NEARCS LICE DAUGE. PUSI.
- 10. BOND EACH ICE DREDGE POST TO GROUND RING WITH \$2.510 LEAD. EXOTHERMICALLY WELD AS TO ICE ESIDOR DOST BELOW TOO OF GRAVE. DACH POST TO TRAVE SEPARATE GROUND LEAD TOO NOT DAISY CIVIN POSTS

- 14. BUND EACH HIFRAME FOST TO MEAREST PORTION OF GROUND SYSTEM WITH #9 8TO LEAD, TXO)TIERMICALLY WELD #2 TO HERAME POST RELOW TO ? OF GRAVEL
- 15, BOND SURFACE MOUNTED CABLE TRAY TO DROUGH FUNG WITH AS STO LEAD. LIGORD TO RIDE OF GRID STRUT CABLE TRAY COVER AND EXOTHERMICALLY. WELDED TO GROUND RING.

13. DUNU LACU COMMSCOPE REAF2 CABINET AND FACH FRICESON SIZE CAB SET TO GROUND RING WITH VZ AWG HINNED SOLID BARE COPPER. CONDUCTOR LUGGED TO CABINET GROUND RAR AND EXOTHERMICALLY WELDED TO GROUND 5 MG, RUN GROUND LEAD IN FLEX CONDUIT ACROSS CONCRETE HAD BELOW CABLE LADDER. THEN DOWN INTO GRAVEL AREA. CONNECT FLEX CONDUIT TO CADINE! ALL ACTURY KNOCKOUT (RBA72) OR PUR. TOOVER PLATE (C120) WITH PORTIVE MECHANICAL FLEX OLD CONDUIT

WITH 82 AWG TIRKED SOLID BARE COPPER CONTUCTOR: BIGGED TO CAUNUI. BODY AND EXCHERMICALLY VALUED TO GROUND RING SUN GROUND; FAD IN FELX CONDUIT ALONG BACK OF RRA72 CABINET, ACROSS CONCRUIL PAD BELOW CASHE LADDES. THEN DOWN INTO GLAVEL AREA, CONNECT TWO HOLE LOS TO BACK OF CASINET AT FACTORY PROVIDED CROUNDING STUDIS.

OF DOND SENERATOR TO GROUND HING WITH #2 STO AT TWO DIAGONALLY. OPPOSITE LOCATIONS BY CRITTING AND LOCKING TWO HOLE LUC TO FINS ON SENERATOR DASE STRUCTURE, SROUND LEADS SHOULD FUR ALONG DASE OF GENERATOR AND TAKE SHORTEST PAHILACKOSS CONCRETE FAD TO GRAVEL

18, JOND GPS ANTENNA and SPS ANTENNA MOUNT TO TSDGA GROUND (VARION). IGE BRIDGE WITH \$2 ORFEN INSULATED STRANGED GROUND WIRE.

20. PROVIDE TWO OROUND RODS OUTSIDE SATES OF COMPOUND, DISTANCE DETWEEN GROUND ROOS STALL MATCH WIDTH OF GATE OFFLING, AND DISTANCE FROM FENCE SHALL, MATCH LENGTH OF LONGEST INDIVIDUAL BATE LEAF, OCNO GALL POSTS TOGE THER WITH \$2 STOTEAR WHICH BUX'S PAST AND CONNECTS TO GROUND FIGUR OUTSIDE GAILS.

- 21. BOND EACH CATS POST WITH 42 STOTIC MEAREST PORTION OF GROUNDING SYSTEM INSIDE COMPOUND
- 22. FOND FACH CATC TO GATE POST WHITH LEXIBLE INSULATED OR BRAIDED. #440 COMPER STRAF, EXCTHERMICALLY WHITE STRAP TO DOTAIN AND SATE

DUNULD OF THE NEAREST GROUND BING. ANY FENCE WITHIN SET OF A GROUND. RING SHALL HAVE THE LINE DOSTS DONULD TO LIFE GROUND RING AT 20FT ALL GROUNDING CONDUCTORS AROW: SHADE SHALL BE NUN IN 26. YELX. PLL. MAXIMUM INTERVALS AS MEASURED ALONG THE EXCEPTION THE PENCH.

> 24, NOT, TY VZW GVIII O INSPECT SKOUND RING SEFORE RACKELLING. CONTRACTOR SHALL HISE A SED PARTY TO PORT ORGAN ILLES, MALL OF POIDNING METHOD GROUND TEST, MAXIMUM AS LOWARD RESISTANCE TO CROUND IS SIGHMS, PROMOF ADOLTONAL GROUND SYSTEM COMPONENTS AS REQUIRED TO ACHIEVE THIS WALUE.

> 25. REFER TO TOWER GROUNDING EXAGRAM AND NOTES FOR GROUND SYSTEM. REQUIREMENTS ON THE TOWER

29. SECUNDING OF ALL FLEDTRICAL FOURMENT SHALL BE AS PER NEC. MUNICIPAL AND UTILITY COMPANY REQUIREMENTS.

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> NOTES AND SPECIFICATIONS


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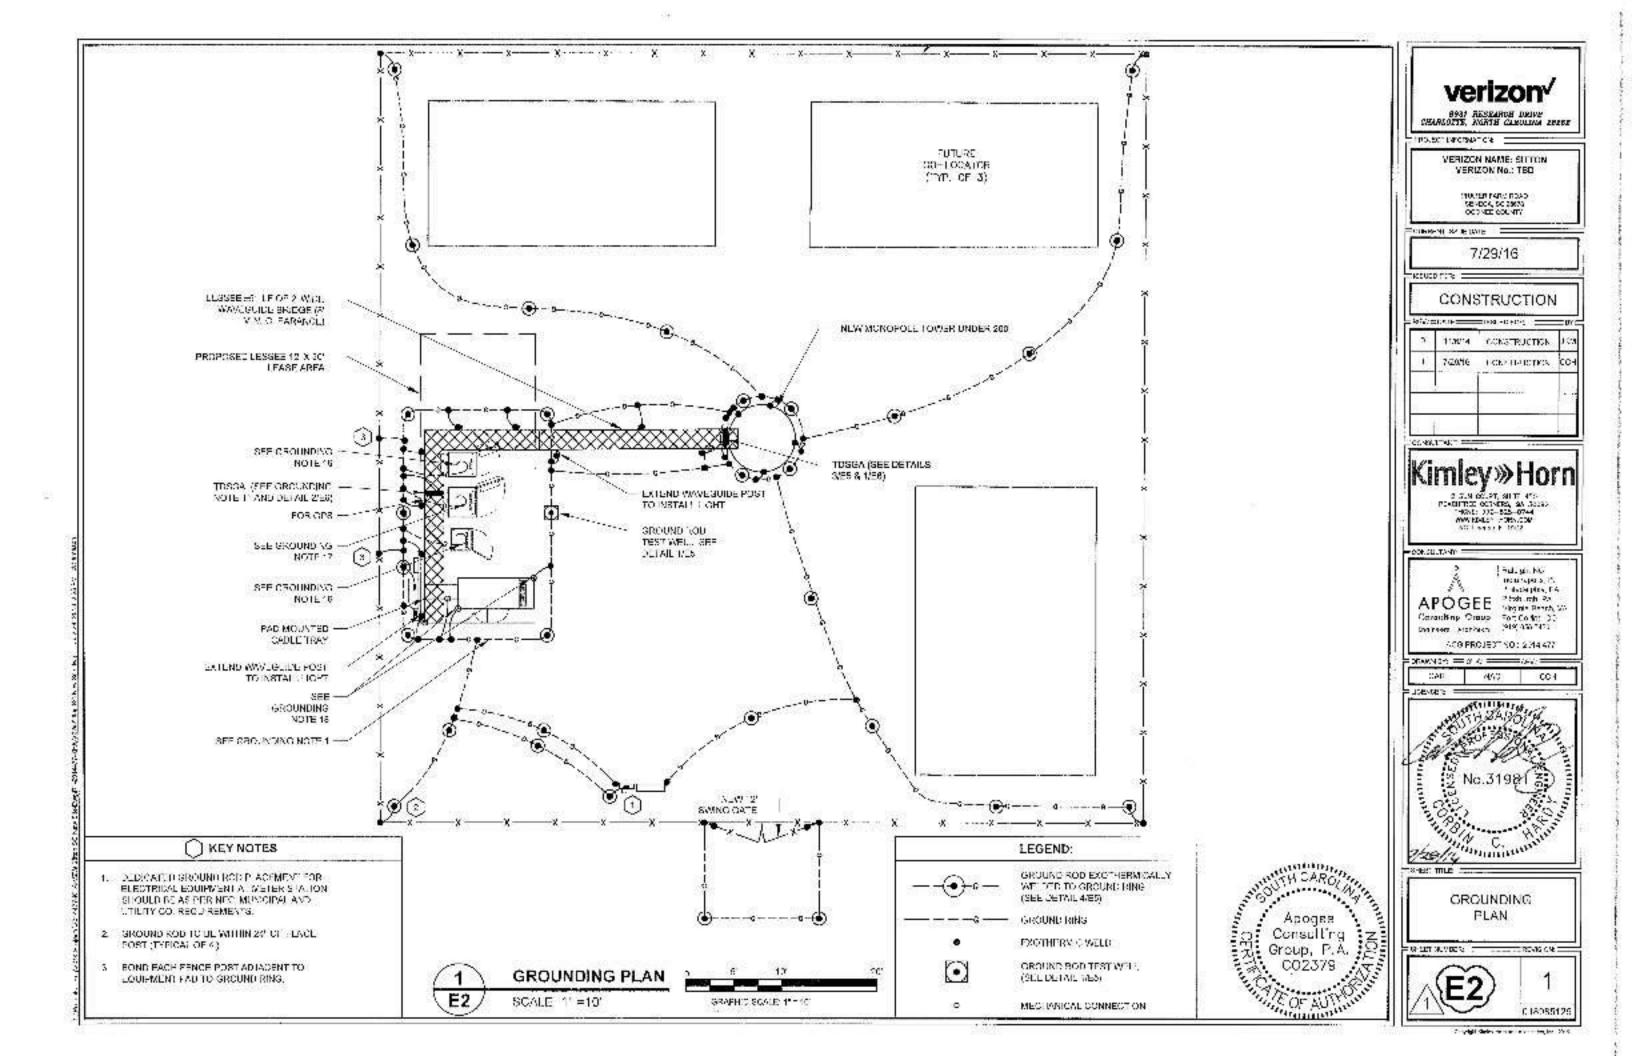
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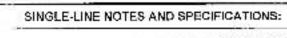
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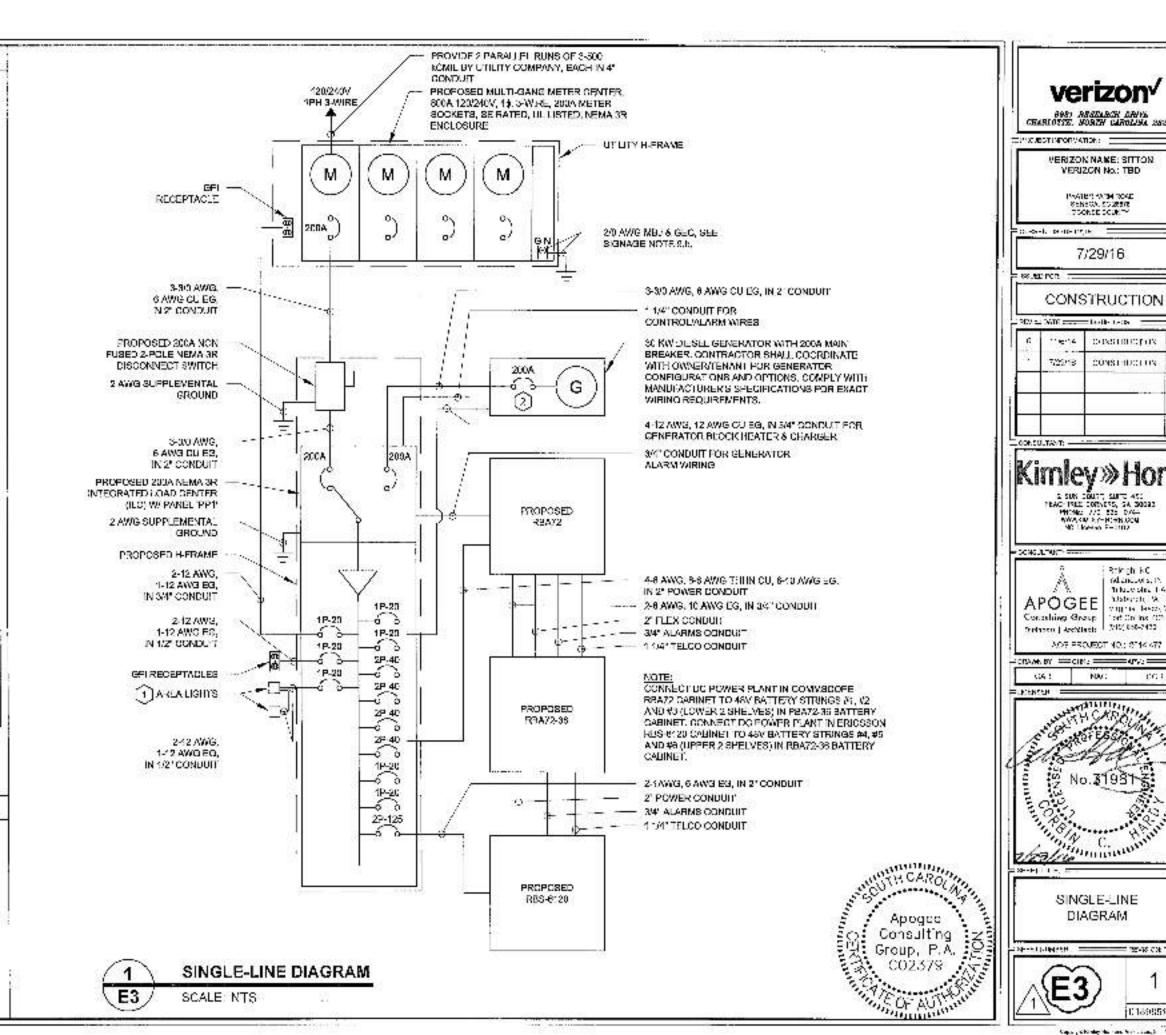
ELECTRIC UTILITY WILL PROVIDE METER AND INCOMING.

- 2 ALL F FOTRICAL WORK SHALL DOMPLY WITH NEC, STATE AND LOCAL CODES.
- CONTRACTOR SHALL ODTAIN OWNER/TEMANT FORIPMENT. 3. DRAWINGS AND REVIEW FOR ADDITIONAL DETAILS AND REQUIREMENTS THAT MAY NOT BE SHOWN IN THESE DRAWINGS CONTRACTOR SHALL COVIETY WITH ANY ADDITIONAL DWINE CHEMANY SPECIFICATIONS AND REQUIREMENTS THAT MAY BE ADDRESSED IN THE EQUIPMEN DAAMINGS.
- 4. PRIOR TO PURCHASING EQUIPMENT THE CONTRACTOR SHALL CONTACT THE ELECTRIC UDULTY AND OBTAIN IN WRITING THE MAXIMUM AVAILABLE FAULT CURRENT AT THE DITHITY SERVICE POINT, PROVIDE MAXIAFO SIGNAGE AS REQUIRED PER REC 110.24. THE CONTRACTOR SHALL ENERGY ALL FLECTRICAL BOD PMENT, CIRCUIT BREAKERS, DISCOANLOTS, 1 USES, AND PANEL BOARDS. HAVE A FAULT CHRRENT INTERRUPTING RATING GREATER THAN THE AVAILABLE HABLE CURRENT IN NO CASE SHALL. THE FAULT OURRENT INTERRUPTING NATING BE LESS. THAN 0,000 AMPS.
- THE GROUNDED SERVICE CONDUCTOR (NEUTRAL CONDUCTOR) SHALL BE OROUNCED AT THE SERVICE. DISCONNECT CALY.
- 5. ALL POWER CIRCUITS SHALL USE COPPER COMBUSTORS WITH THEN, THAN INSULATION, ALL TERMINATIONS SHALL BERMIED FOR AT LEAST / NOOGREES OF
- 7. CONTRACTO USHALL PROVIDE GROUND FARILT ORCHIT. INTERRIPTER (CFI) TYPE RECEPTABLES.
- CONTRACTOR SHALL EASURE ALL NEUTRAL CONDUCTORS HAVE WHITE INSULATION AND EQUIPMENT. CROCKE CONDUCTORS HAVE GREEN INSULATION, GOLDRI APE DENTIFICATION OF THESE CORDUCTORS IS NOT
- 9. PER NEC ART 702 PROVIDE SIGNAGE AS FOLLOWS: AT PANEL PPI AND DISCONNECT; TEMERGENCY FOWER IS SUPPLIED BY STANC-BY GENERALOR. LOCALLE ON OTHER SIDE OF PARIL!
- AT SERVICE DISCONNECT:

WARNING - SHOCK HAZARD EXISTS IF BROUNDING ELECTROBE CONDUCTOR OR BONDING JUMPER. CONNECTION IN THIS FOLLEMENT, IS REVOVED WHILE ALTERNATE SOURCE:S) IS ENERGIZED, OPENING THE EQUIPMENT DISCONNECT WILL CAUSE THE EMERGENCY. GUND WIGHTO STAND TO REVOVE POWER ENTIRELY. FROM THE ROUIPMENT. THE GEVERATOR YEST BE TURNED. OLI AND THE GENERATOR BREAKER MUST BE OPEN.

() KEY NOTES

- AREA LIGHT LITTLEN WHITE 250V, SOWN DNA 121, CONTROL MA CONTRACTOR PROVIDED MANUAL TIMER SWITCH. (WEATHERPROOF)
- THE GENERATOR USED IN CONJUNCTION WITH A SPOLE. AUTOWAT O TRANSFER SWITCH WITH A SOLD NEUTRAL SINGLA SURW WILLY SURVED SYSTEM, AS SUCH DO NOT BOND THE RELITEAL TO ORGUND AT THE GENERATOR.

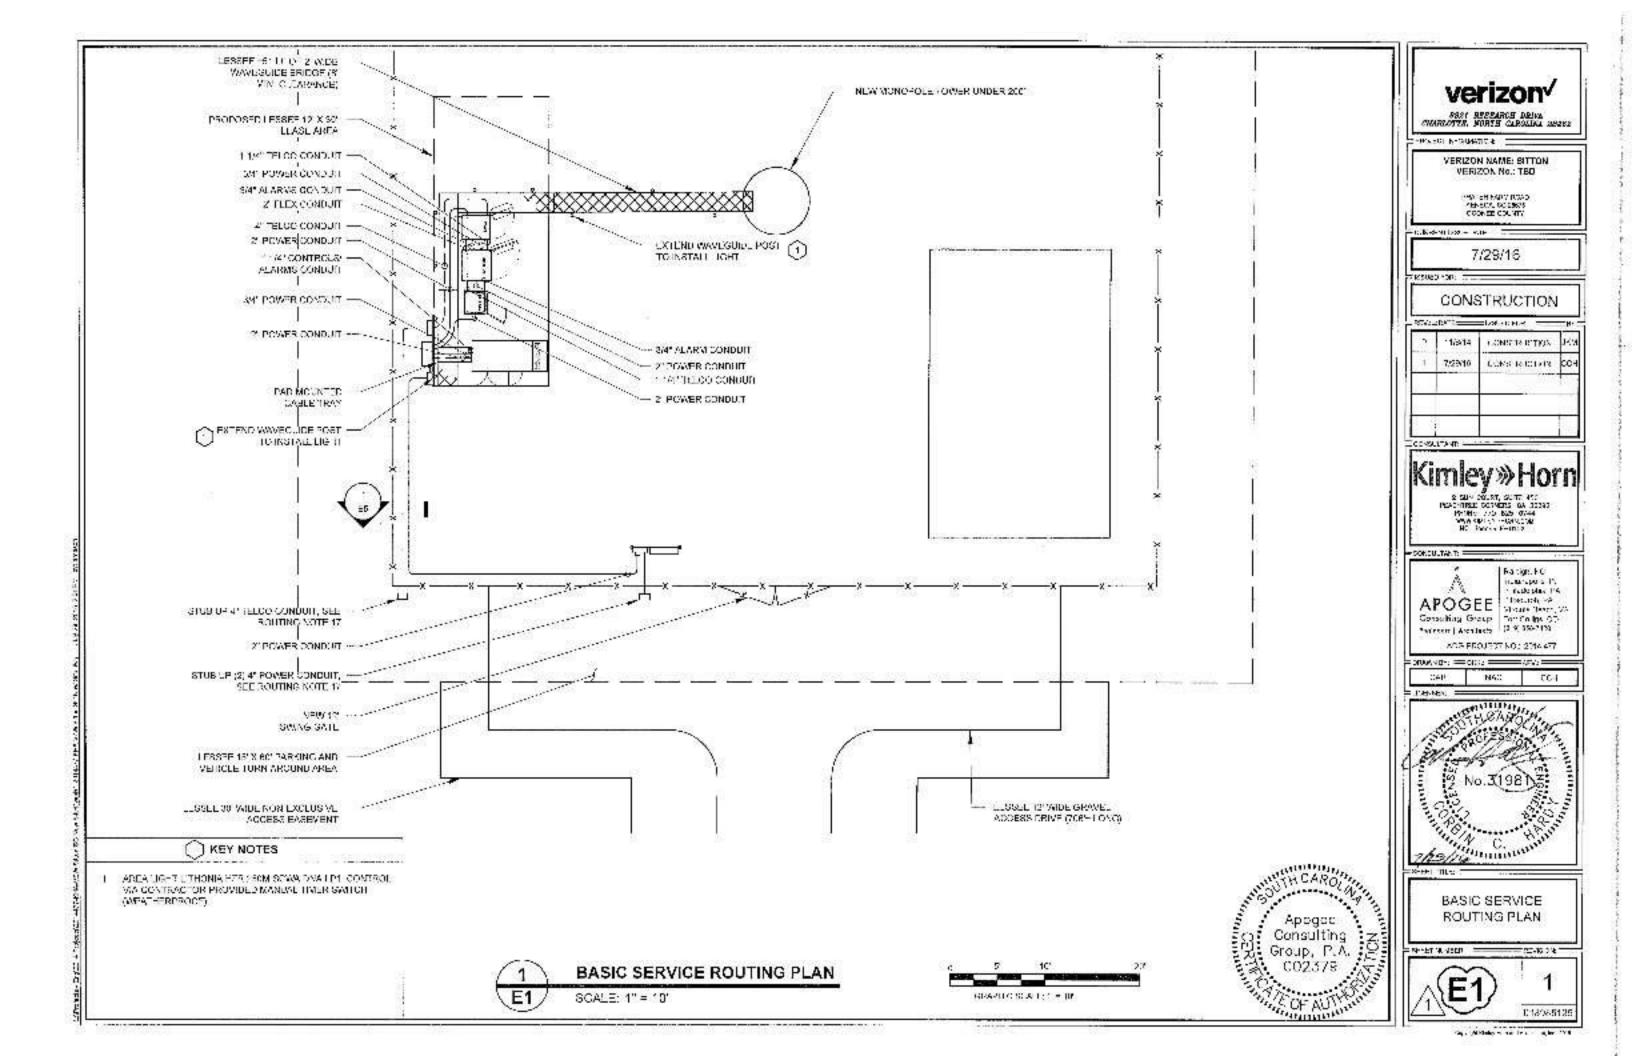

VERIZON NAME: SITTON

VERIZON No.: TBD

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PEAC-TREE COUNTYS, GA 30023

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SSSI RESEARCH DRIVE CHARGOTTE, NORTH CAROLINA SHORE

MODEL INSTRUCTOR I

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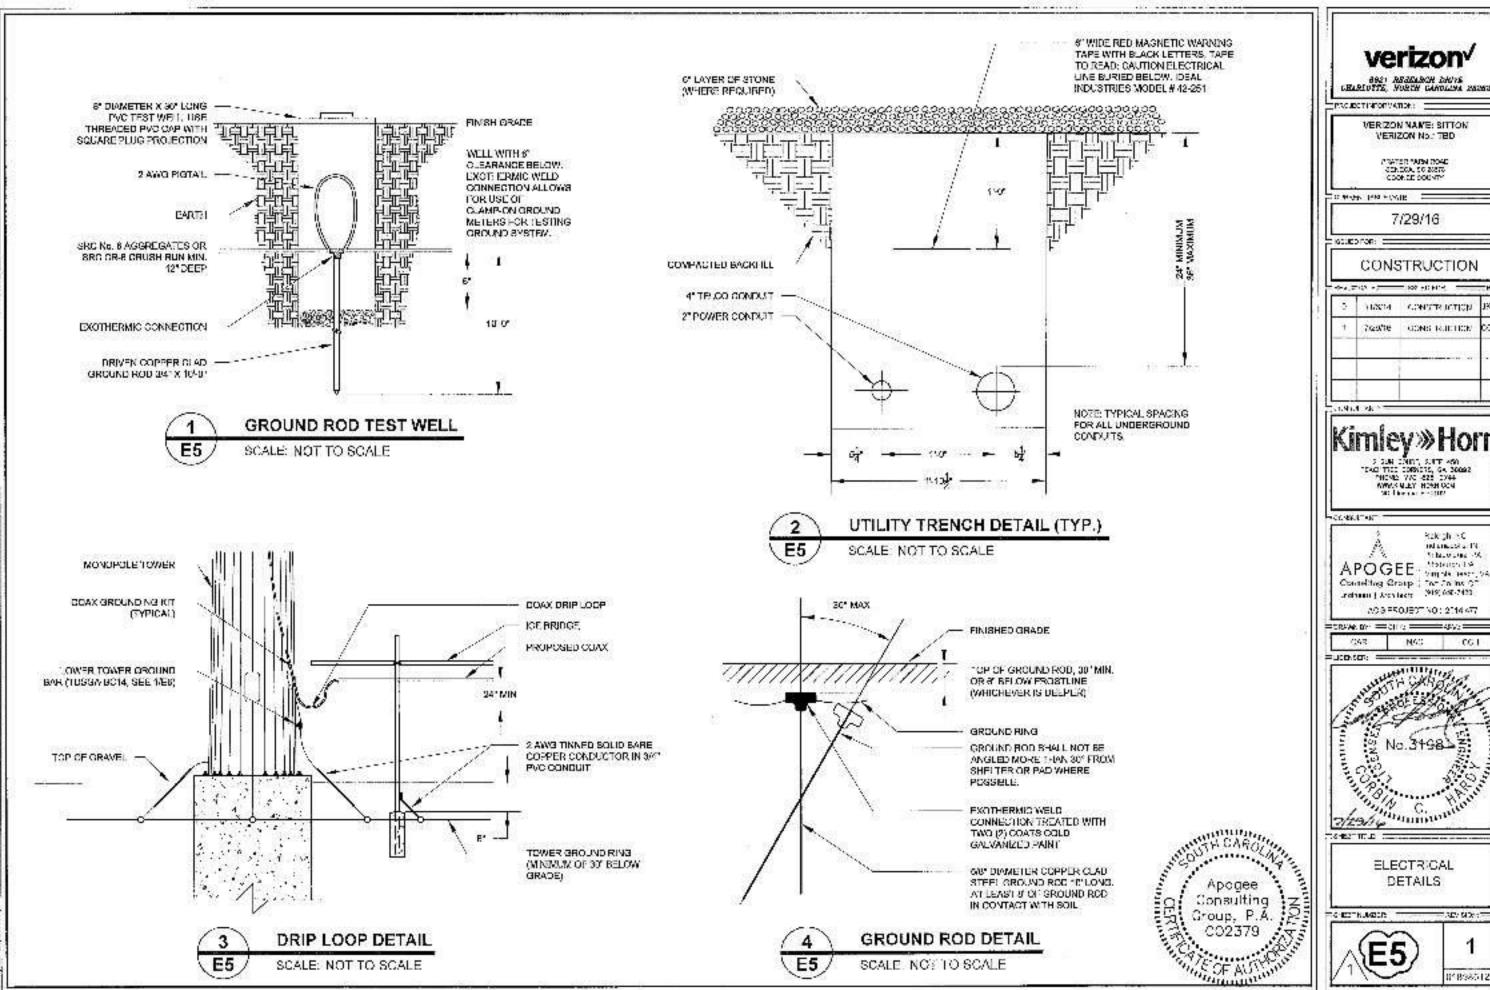
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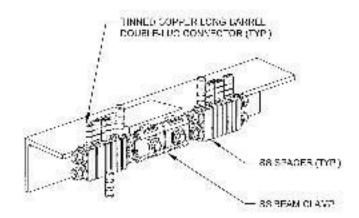
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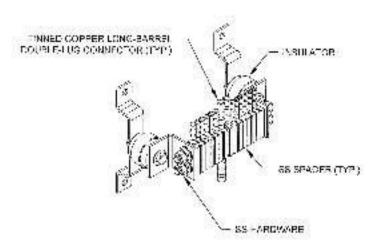
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TDSGA-BC14 GROUND BAR

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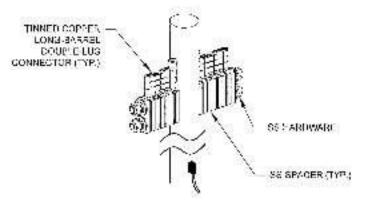


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TDSGA-WB17 GROUND BAR


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BAR NONE POST MOUNTED

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DIRECT RESEARCH DRIVET CHARLOTTE, KONTH CAROLINA ARROS

VERIZON NAME: SITTON

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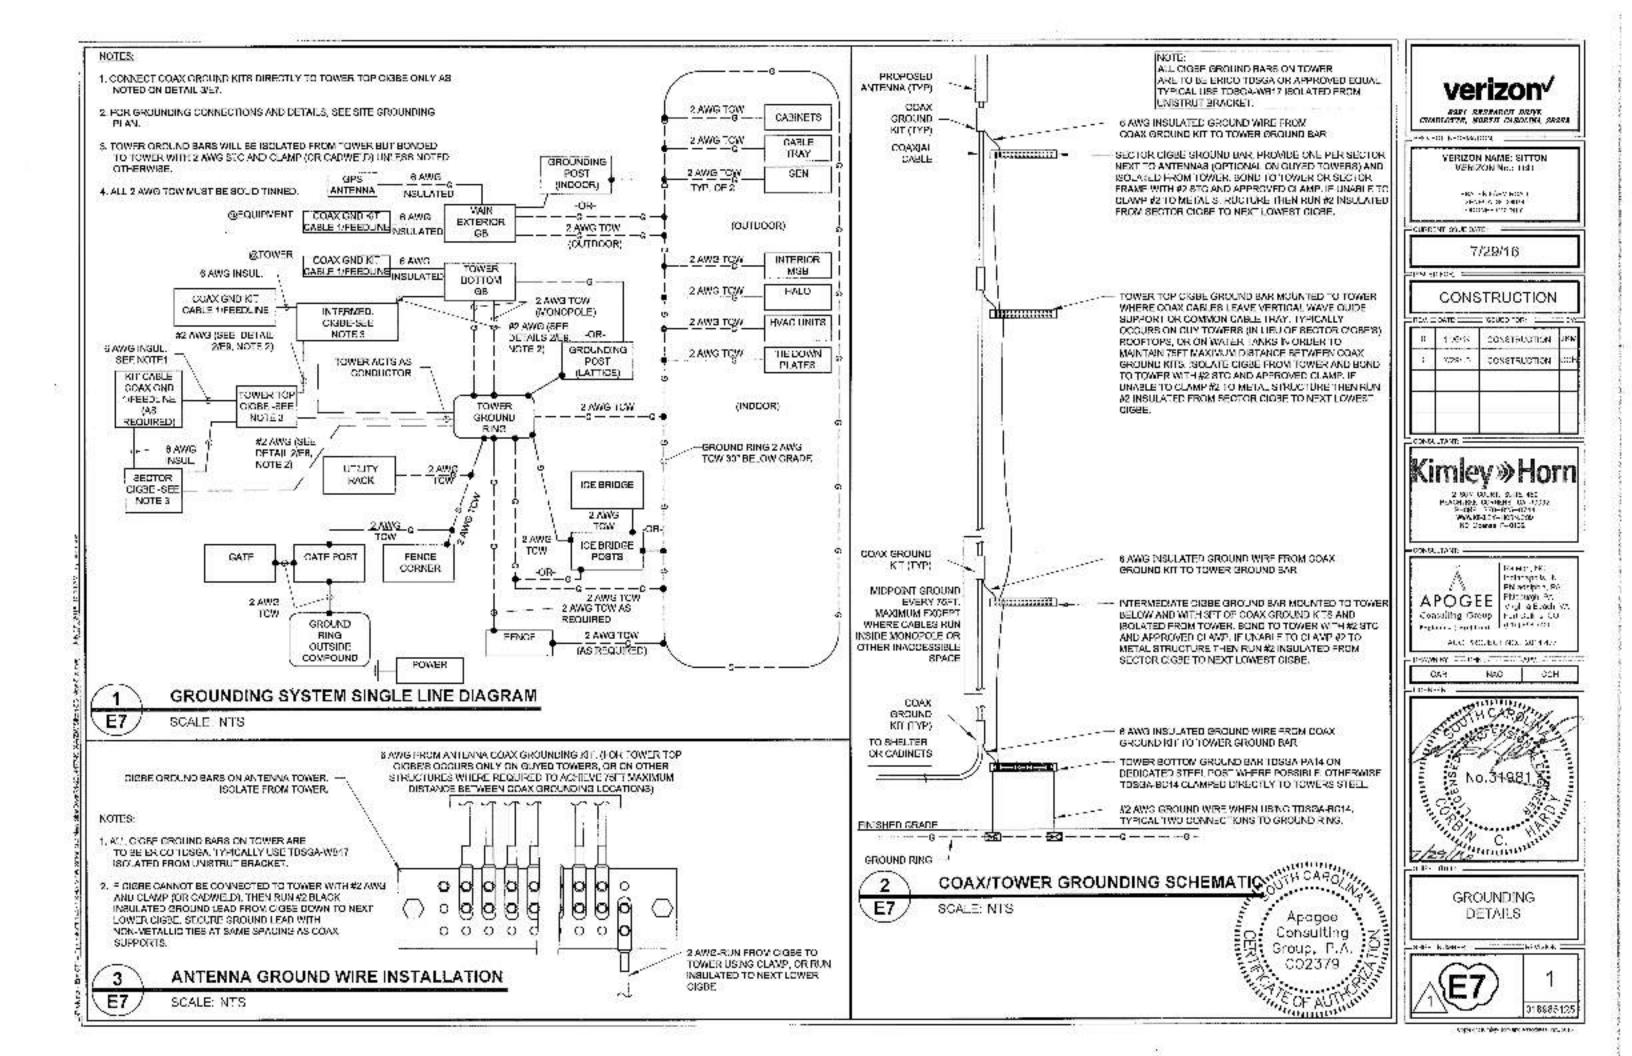
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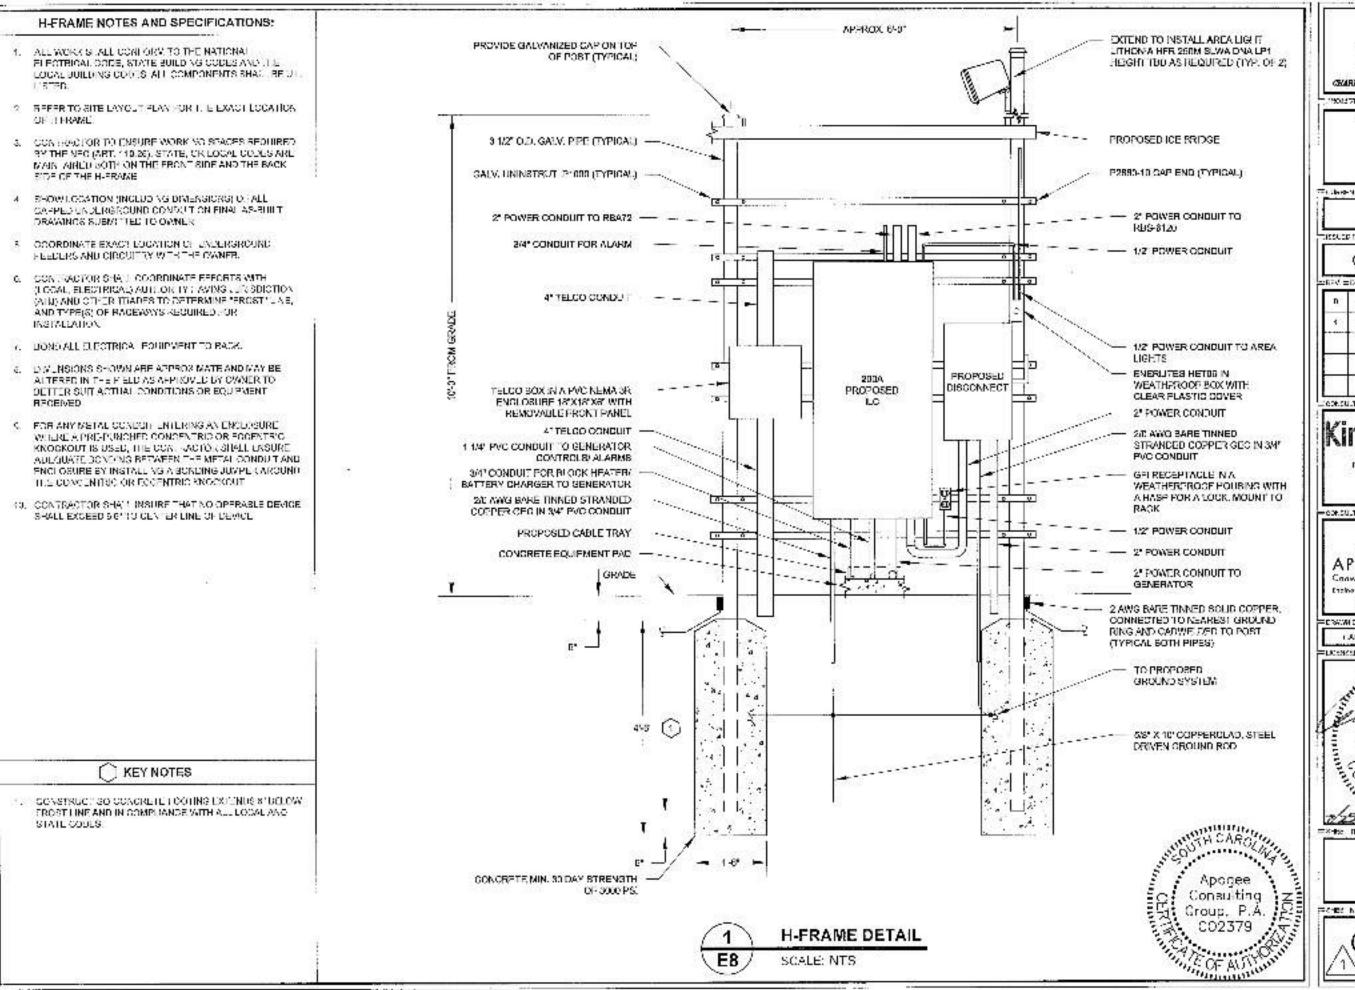
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7/29/16

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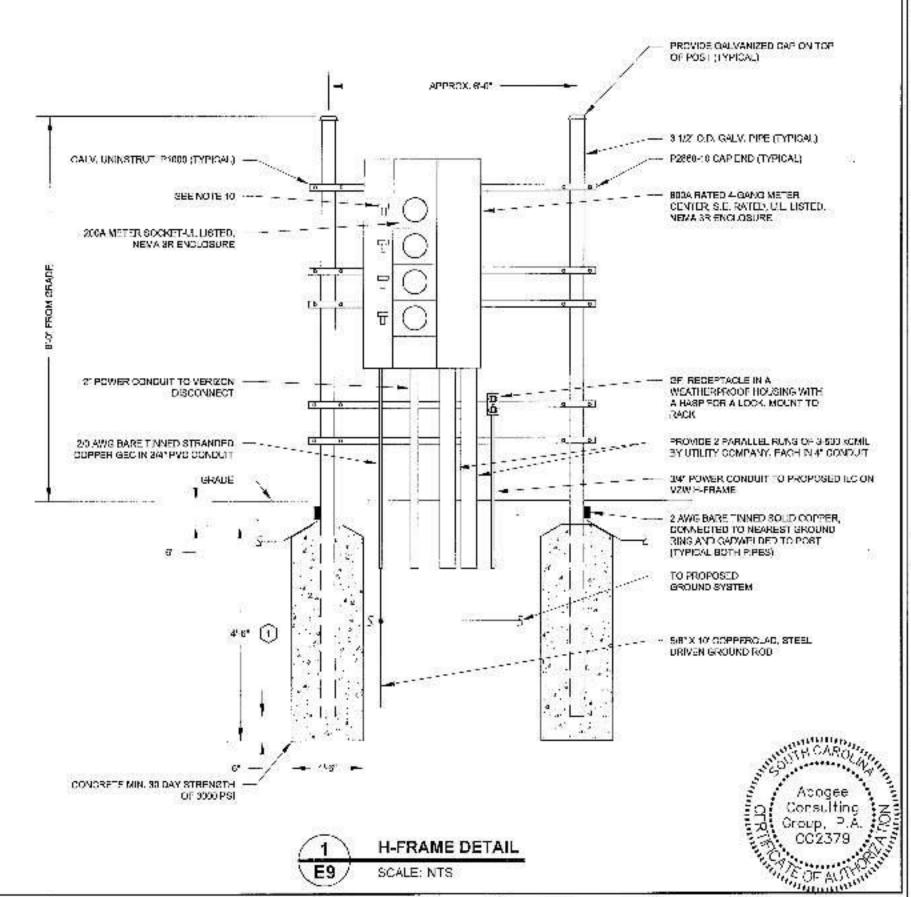
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H-FRAME NOTES AND SPECIFICATIONS:

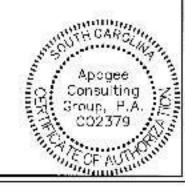- ALL WORK STATE CONFORM TO THE NATIONAL FLECTRICAL CODE STATE SHILDING CODES AND THE LOCAL BUILDING CODES, ALE COMPONENTS SHALL BE U.L.
- 2. REFER TO SITE LAYOUT PLAN FOR THE EXACT LODATION OF THE VAME
- 3. CONTRACTOR TO ENSURE WORKING SHACES REQUIRED. BY THE NEO WAST, 110,28;, STATE, OR LOGAL CODES ARE MAINTAINED DOTH ON THE FRONT SIDE ARD THE DACK SIDE OF THE HIFRAME.
- SHOW LOGATION (INCLUDING DIMENSIONS) OF ALL CAPPED UNDERGROUND CONDUITION FINAL AS BUILT. DRAWINGS SUBVITTED TO CWIER.
- 5. COORDINATE EXACT LOCATION OF UNDERGROUND FEEDERS AND CIRCUITRY WITH THE OWNER.
- CONTRACTOR SHALL COORDINATE EFFORTS WITH (LOCAL, ELECTRICAL) ALTHORITY HAVING JURISCICTION. (AHJ) AND OTHER TRADES TO DETERMINE "FROST"... NO. AND TYPE(S) OF SAGEWAYS REQUIRED FOR ING VALLATION.
- BOND ALL ELECTRICAL EQUIPMENT TO RACK.
- DIMENSIONS SHOWN ARE ADDROXIMATE AND MAY BE ALTERED IN THE RIBLE AS APPROVED BY CVANER TO PETTER SUIT ACTUAL CONDITIONS OR EQUIPMENT.
- FOR ANY METAL CONDUIT EATERING AN ENCLOSURE. WHERE A PRE-PUNCKED CONCENTRIC OR ECCENTRIC KNOCKOUT IS USED, THE CONTRACTOR SHALL ENSURE ADEQUATE BONDING BETWEEN THE METAL CONDUIT AND ENGLIGURE BY INSTALLING A BONDING JUMPER AROUND THE CONCENTRIC OF ECCENTRIC KNOCKOUT.
- 10 CONTRACTOR SHALL INSURE THAT NO OPERADLE DEVICE. SHALL EXCEED 6'9" TO DENTER LINE OF DEVICE.

KEY NOTES

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verizon^v

SHARLOTTE, MORTH CAROLINA 28884

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VERIZON NAME: BITTON VERIZON No.: TBD

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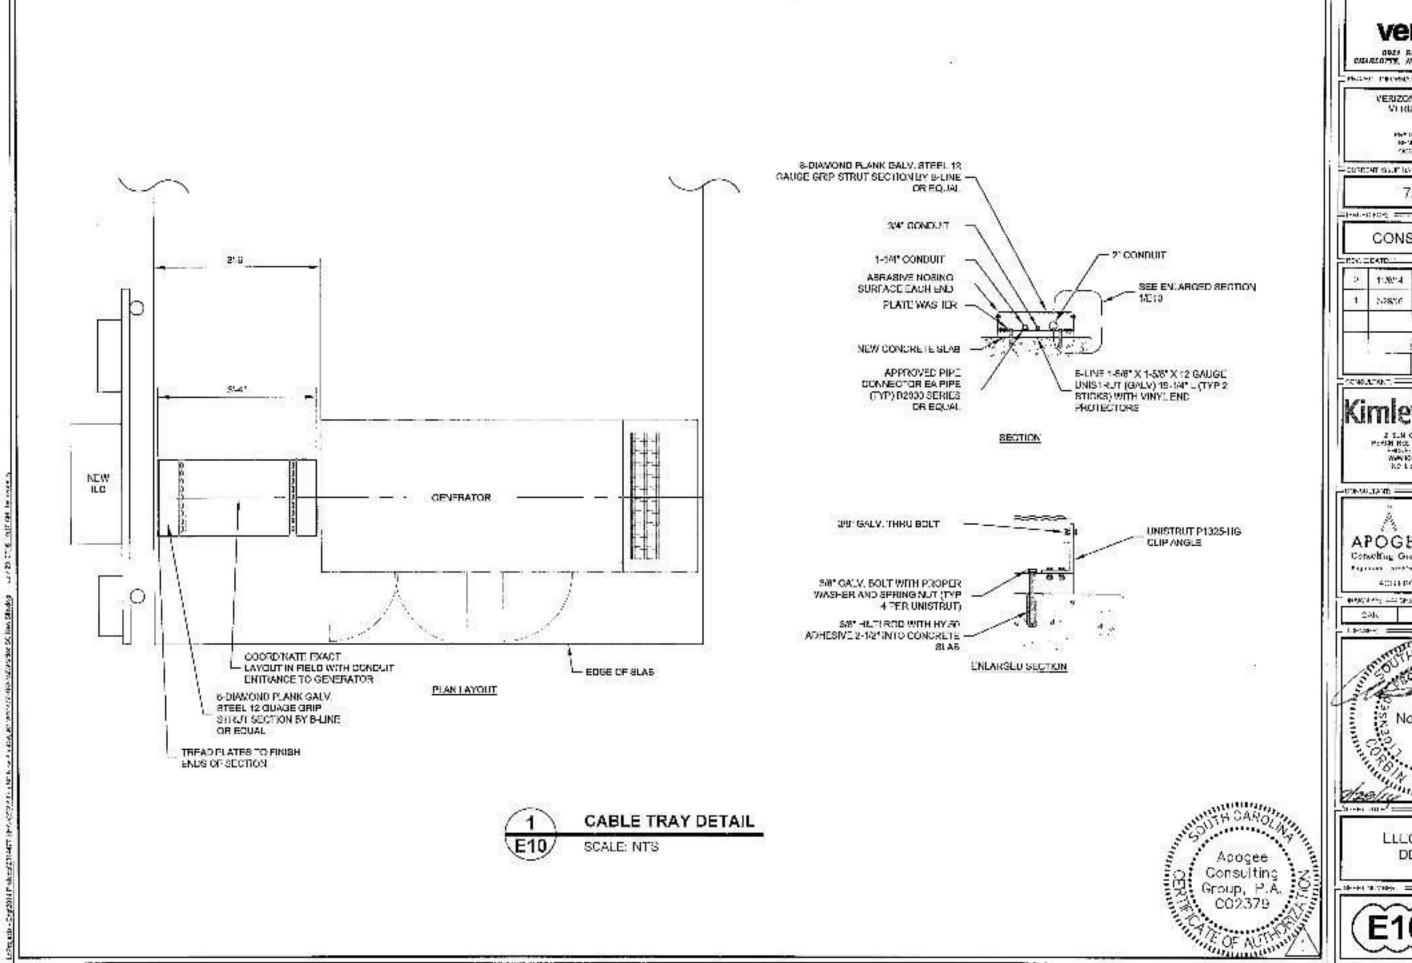
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CHARLOTTE, NORTH CAROLINA 24243

VERIZON NAME: SITTON VERIZON No.: TBD

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Network Operations



February 3, 2017

Greg Gordos, Senior Planner
Oconee County Community Development Department
Planning and Zoning Division
415 South Pine Street
Walhalla, SC 29691

Re: Proposed Verizon Wireless Telecommunications Tower on Prater Farm
Road

Tax/Pin R2910002012

Verizon Site Name: STTTON

To whom it may concern:

I am providing this Letter to comply with Zoning Code Section 32-133 (b). Verizon Wireless engineers have determined that the Verizon Wireless network requires that the tower that we are referring as "SITTON." be located within a certain portion of Oconee County.

Verizon Wireless had done a review of said area to locate any existing sites that could serve as an alternative to constructing a new tower. After doing a thorough review of the search area, Verizon Wireless was not able to locate any existing cell towers or buildings that are of adequate height to provide a co-location option for these antennas (165'). Verizon's evaluation included reviewing the possibility of co-locating on existing towers or structures, including electric utility company transmission line towers; and/or reconstruction of, or new construction within the footprints of existing electric utility company transmission line towers;

Also, we inquired and were informed by Oconee County that there were no sites near this proposed site that were preselected in the county-wide communication tower site study.

Very truly yours,

Michael Haven

Verizon Wireless Manager

RE/ Regulatory



9221 Lyndon B. Johnson Freeway, #204, Dallas, TX 75243 ★ PHONE 972-231-8893 ★ FAX 1-866-364-8375 www.allprocqi.com ★ e-mail: info@allprocqi.com

February 3, 2017

Oconee County Community Development 415 S Pine St. Walhalla, South Carolina 29691

Ref: Site Name –Sitton– 165' Monopole Tower

ACGI# 17-0670

Jurisdiction: Oconee County, SC

Site Address: Prater Farm Road, Seneca, SC 28676 Scope of Work: Engineering Specification Letter

Applicable Code:

IBC 2015 & ASCE 7–10, ANSI/TIA-222-G, Risk Category II, International Fire Code, 2015 edition Wind Speed: IBC2015(115 mph ultimate wind speed), ANSI/TIA-222-G (Equivalent 89 mph

nominal wind speed), Exposure "C"

This letter is provided in reference to the above mentioned site for the following specifications:

- The purpose of this tower is to support telecommunication antenna equipment for cellular coverage of the affected area.
- 2. Above reference tower to be designed to meet or exceed industry standards defined by ANSI/TIA-222-G, "Structural Standard for Antenna Supporting Structures and Antennas" (ANSI/TIA-222-G Standard).
- The total height of tower is 165' with highest appurtenance to 174'. All site location data to be re-verified by survey.
- 4. Above reference tower shall be constructed and contain only equipment meeting standards of the Federal Communication Commission (FCC) regulations; and comply with all other applicable federal, state, and local regulations.
- 5. The power density of the above reference site shall not exceed federally approved levels, or American National Standards Institute (ANSI) standards, whichever provides for stricter requirements. The tower shall be designed and constructed meeting the requirements of International Fire Code, 2015 edition.
- 6. The tower must be designed and certified by an Engineer to be structurally sound and as a minimum in conformance with the adopted Building code. This tower to be designed using the following minimum wind speed criteria as defined by ANSI/TIA-222-G for Oconee County, SC:
 - i) 89 mph 3-second-gust nominal wind speed with no ice.
 - ii) 30 mph 3-second-gust wind speed with 0.75" ice.

The "3-second-gust wind speed refers to a wind measured at 33 ft. above the ground. Equations in ANSI/TIA-222-G Standard take into account that the wind speed escalates with the increasing height of the tower.

If you have any other questions or concerns regarding our recommendations, please contact us.

Sincerely,

Jingcheng Li, EIT

02/03/2017



Approved by:

Joji M. George, P.E SC PE # 26840

REFERENCE COPY

This is not an official FCC license. It is a record of public information contained in the FCC's licensing database on the date that this reference copy was generated. In cases where FCC rules require the presentation, posting, or display of an FCC license, this document may not be used in place of an official FCC license.



Federal Communications Commission

Wireless Telecommunications Bureau

RADIO STATION AUTHORIZATION

LICENSEE: CELLCO PARTNERSHIP

ATTN: REGULATORY CELLCO PARTNERSHIP 5055 NORTH POINT PKWY, NP2NE NETWORK ENGINEERING ALPHARETTA, GA 30022

Call Sign WPUD533	File Number		
Radio Service CW - PCS Broadband			

FCC Registration Number (FRN): 0003290673

Grant Date 02-06-2008	Effective Date 11-01-2016	Expiration Date 12-29-2017	Print Date
Market Number BTA016	Chan	nel Block C	Sub-Market Designator
		et Name son, SC	
1st Build-out Date 12-29-2002	2nd Build-out Date	3rd Build-out Date	4th Build-out Date


Waivers/Conditions:


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Conditions:


Pursuant to §309(h) of the Communications Act of 1934, as amended, 47 U.S.C. §309(h), this license is subject to the following conditions: This license shall not vest in the licensee any right to operate the station nor any right in the use of the frequencies designated in the license beyond the term thereof nor in any other manner than authorized herein. Neither the license nor the right granted thereunder shall be assigned or otherwise transferred in violation of the Communications Act of 1934, as amended. See 47 U.S.C. § 310(d). This license is subject in terms to the right of use or control conferred by §706 of the Communications Act of 1934, as amended. See 47 U.S.C. §606.

This license may not authorize operation throughout the entire geographic area or spectrum identified on the hardcopy version. To view the specific geographic area and spectrum authorized by this license, refer to the Spectrum and Market Area information under the Market Tab of the license record in the Universal Licensing System (ULS). To view the license record, go to the ULS homepage at http://wireless.fcc.gov/uls/index.htm?job=home and select "License Search". Follow the instructions on how to search for license information.



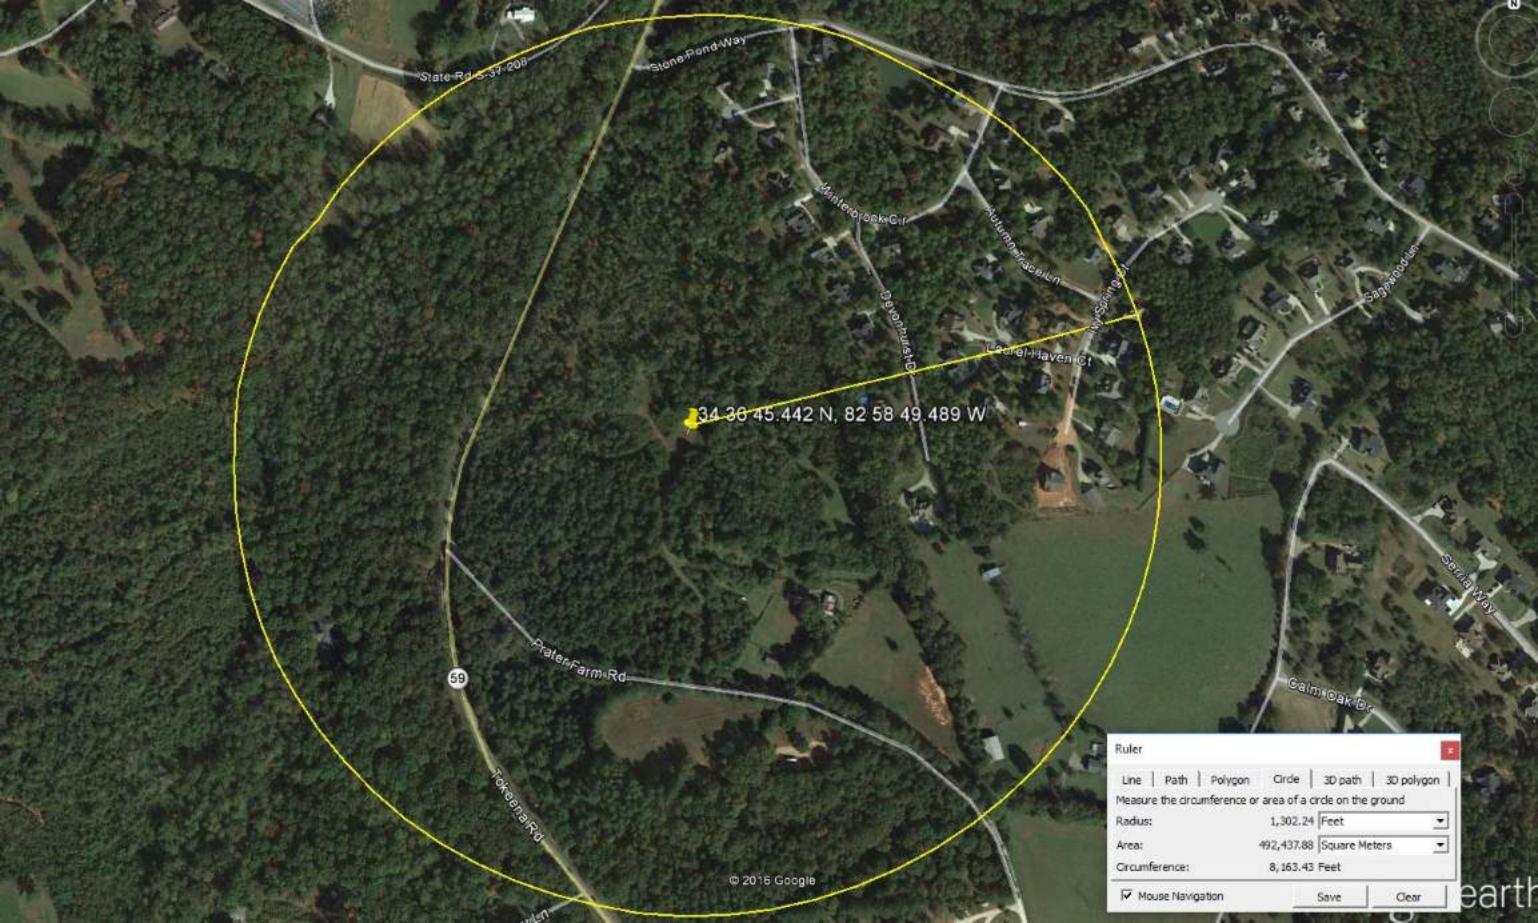

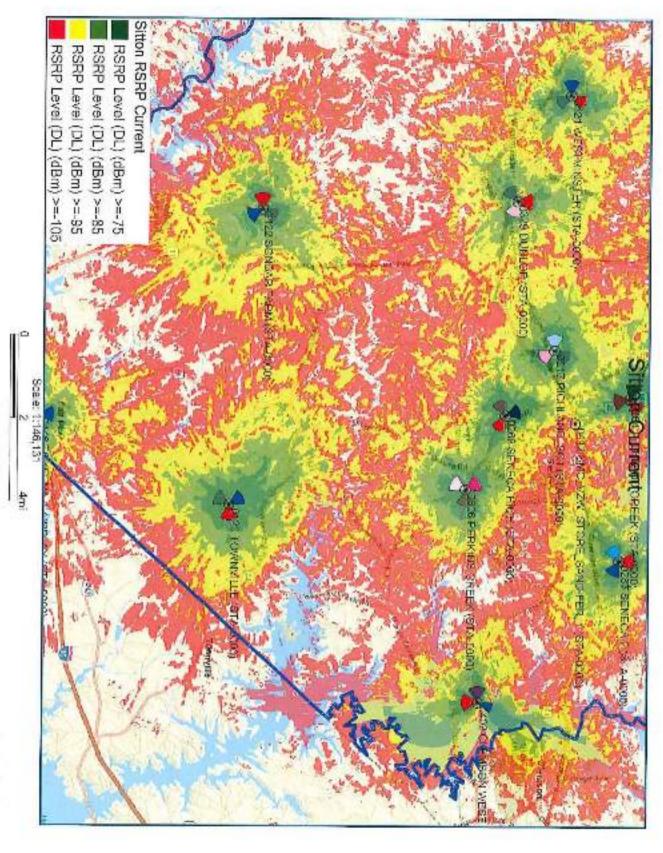Design Scale 1: 100,000

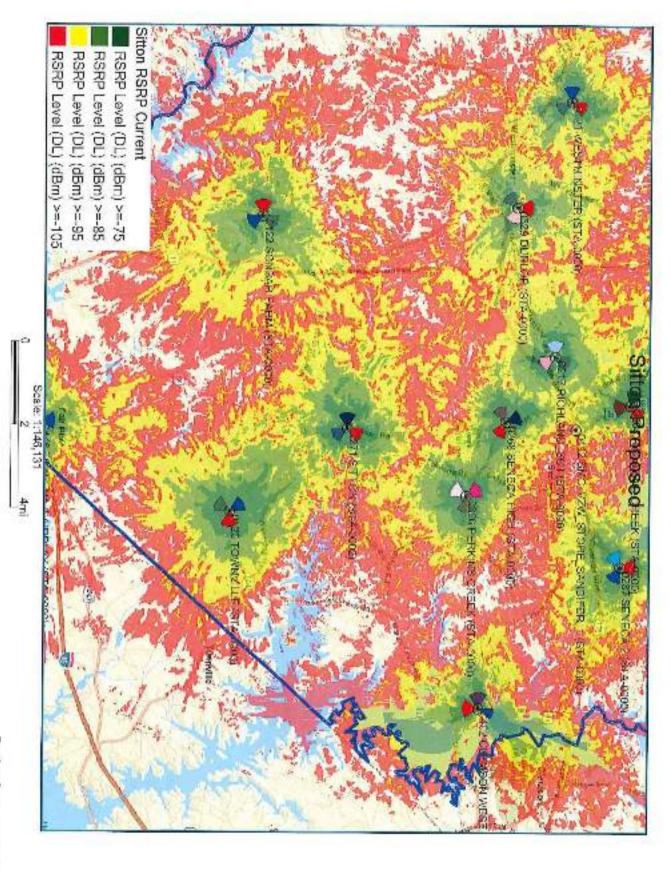

Design Scale 1: 100,000



February 20, 2017

Mr. Keith Markland Kimley-Horn and Associates, Inc. 10 Roswell Street #210 Alpharetta, GA 30009

Re: Sitton Site

Gould Digital Imaging 165' Balloon Test Report

My name is Michael Gould, and I am owner and operator of Gould Digital Imaging. Kimley-Horn and Associates hired Gould Digital Imaging to perform various aspects of photographic imaging work in connection with the development of Verizon Wireless' telecommunications services network in the Seneca, SC metropolitan area.

I have over eighteen years' experience working specifically with telecommunications companies including T-Mobile, Inc., AT&T Wireless, Verizon Wireless, Nextel, Alltel, Cricket, Sprint PCS, COMPASS Technology Services, Inc., Crown Castle International, Vertical Bridge, and American Tower Corporation in preparing photographic simulations of telecommunications towers. I have a Bachelors Degree in Art from St. Mary's College of Maryland; over twenty years of professional experience in the field of digital photographic enhancement and I have produced approximately 6,000 photographic simulations for Verizon Wireless, AT&T, T-Mobile, Inc., American Tower Corp., and other telecommunications services companies.

Kimley-Horn and Associates hired Gould Digital Imaging to perform a "165 foot Balloon Test" at Verizon Wireless' Sitton site on Prater Farm Road, in Seneca, SC. A balloon test is a visual reference of how tall a proposed structure would appear if constructed. A ten foot long red blimp shaped helium balloon is filled and raised above the proposed site on a measured line to the height of the proposed structure and anchored to the ground at the proposed site.

At approximately 10:45am on Tuesday, February 13th, 2017, the balloon was raised to a height of 165 feet to the bottom of the blimp and anchored at the center of the leased area. The wind was relatively calm and the balloon was flying directly above its anchor throughout the entire test. The balloon was left aloft until 11:30am.

I drove around the surrounding "area of affect" and took photographs from several adjoining properties and other points of potential visual impact. I deployed the use of a hand held GPS unit that indicated the bearing and distance I was from the balloon as I canvassed the area for any possible views of the balloon.

This report includes a site photography map denoting the location of the proposed tower and the locations of all photographs that were taken of the site as well as copies of the photographs.

In my professional opinion, these photographs reflect to a reasonable certainty the anticipated projection of the height of the tower if constructed at the Sitton site. If you need any additional information, please do not hesitate to call me at (770) 617-2958 or e-mail at michael@goulddigitalimaging.com.

Sincerely,

Gould Digital ImagingMichael D. Gould/Owner









































CERTIFICATE OF LIABILITY INSURANCE

DATE(MM/DD/YYYY) 02/01/2017

THIS CERTIFICATE IS ISSUED AS A MATTER OF INFORMATION ONLY AND CONFERS NO RIGHTS UPON THE CERTIFICATE HOLDER. THIS CERTIFICATE DOES NOT AFFIRMATIVELY OR NEGATIVELY AMEND, EXTEND OR ALTER THE COVERAGE AFFORDED BY THE POLICIES BELOW. THIS CERTIFICATE OF INSURANCE DOES NOT CONSTITUTE A CONTRACT BETWEEN THE ISSUING INSURER(S), AUTHORIZED REPRESENTATIVE OR PRODUCER, AND THE CERTIFICATE HOLDER.

IMPORTANT: If the certificate holder is an ADDITIONAL INSURED, the policy(ies) must have ADDITIONAL INSURED provisions or be endorsed.

this certificate does not confer rights to the certificate holder in	litions of the policy, certain policies may require an endorsement. A statel n lieu of such endorsement(s).	ment on
PRODUCER Aon Risk Services Northeast, Inc. New York NY Office 199 Water Street New York NY 10038-3551 USA	CONTACT NAME: PHONE (A/C. No. Ext): (866) 283-7122 E-MAIL ADDRESS: FAX (A/C. No.): (800) 363-0105	
	INSURER(S) AFFORDING COVERAGE	NAIC#
INSURED	INSURER A: National Union Fire Ins Co of Pittsburgh 19	445
Verizon Wireless, LLC	INSURER B:	
1095 Avenue of the Americas New York NY 10036 USA	INSURER C:	
	INSURER D:	
	INSURER E:	
	INSURER F:	
COVERAGES CERTIFICATE NUMBER: 5700	0065432201 REVISION NUMBER:	
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									PERSONAL & ADV INJURY	\$1,000,000							
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	(Mandatory in NH) If yes, describe under DESCRIPTION OF OPERATIONS below											E.L. DISEASE-EA EMPLOYEE					
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DESC	RIPT	ION OF	F OPERATIO	ONS /	LOC	ATIONS / VEHICL	ES (A	CORD 1	 01, Additional Remarks Schedule, may be	attached if more	space is require	d)					

RE: Verizon New Build Site "Sitton", PS Location #303546. Oconee County is included as an Additional Insured with respect to the General Liability policy.

CERTIFICATE HOLDER

Oconee County Community Development
Planning & Zoning Division
415 S. Pine St.
Walhalla SC 29691 USA **CANCELLATION**

SHOULD ANY OF THE ABOVE DESCRIBED POLICIES BE CANCELLED BEFORE THE EXPIRATION DATE THEREOF, NOTICE WILL BE DELIVERED IN ACCORDANCE WITH THE

AUTHORIZED REPRESENTATIVE



Inspired ideas.
Integrated real estate solutions.

April 4, 2017

Board of Zoning Appeals Oconee County Community Development 415 S. Pine Street Walhalla, SC 29691

RE: Hartwell Village / Requested Variance for Internal Side Setbacks

Hartwell Village is a proposed commercial/mixed use project at the intersection of Highway 123 (Clemson Boulevard) and SC 93 (Pendleton Road). The property has a zoning classification of Control Free District (CFD) and has been subdivided into 8 lots and may be further subdivided as necessary to complete the development of the project. Commercial developments, specifically shopping centers are typically subdivided to allow for separate ownerships, phasing of the development and/or to meet financing conditions. In many cases a shopping center appears as one property but is actually subdivided into several parcels with private agreements addressing the common development and operation of the center creating a center with a unified appearance and operation.

We are requesting a variance from the 5 foot side setbacks contained within the CFD to allow a zero setback for internal lot lines. The zero setback on the internal lot lines will allow for the shopping center to be developed as a unified project without separation between buildings due solely to side setbacks. A zero side setback is fairly common within a shopping center or Unified Commercial Development. The requirement for a setback between buildings within the center would create a condition that will restrict the ability to develop the shopping center appropriately and utilize the property by requiring a 10 foot separation between buildings on separate lots. We believe the approval of the variance is consistent with other shopping centers within Oconee County and does not create a detriment to the public good or damage adjacent properties within the area. Lastly, the approval of this variance request will not change any of the allowed uses on the property.

I have attached the current subdivision of the property and the approved site plan for reference. In order to phase the project, lot 2 will be further subdivided to allow the phasing of the project. The areas in red and yellow on the attached site plan will be constructed as the first phase of the center (including all necessary parking and access roads). The granting of the variance will allow for the future construction of buildings

adjacent to the initial phase and to meet the requirements for financing the project in phases.


We respectfully request your approval of the requested variance to allow zero setback for internal lot lines at Hartwell Village.


I VUMMAN

Thomas Lowell

Vice President of Construction and Development

CASTO

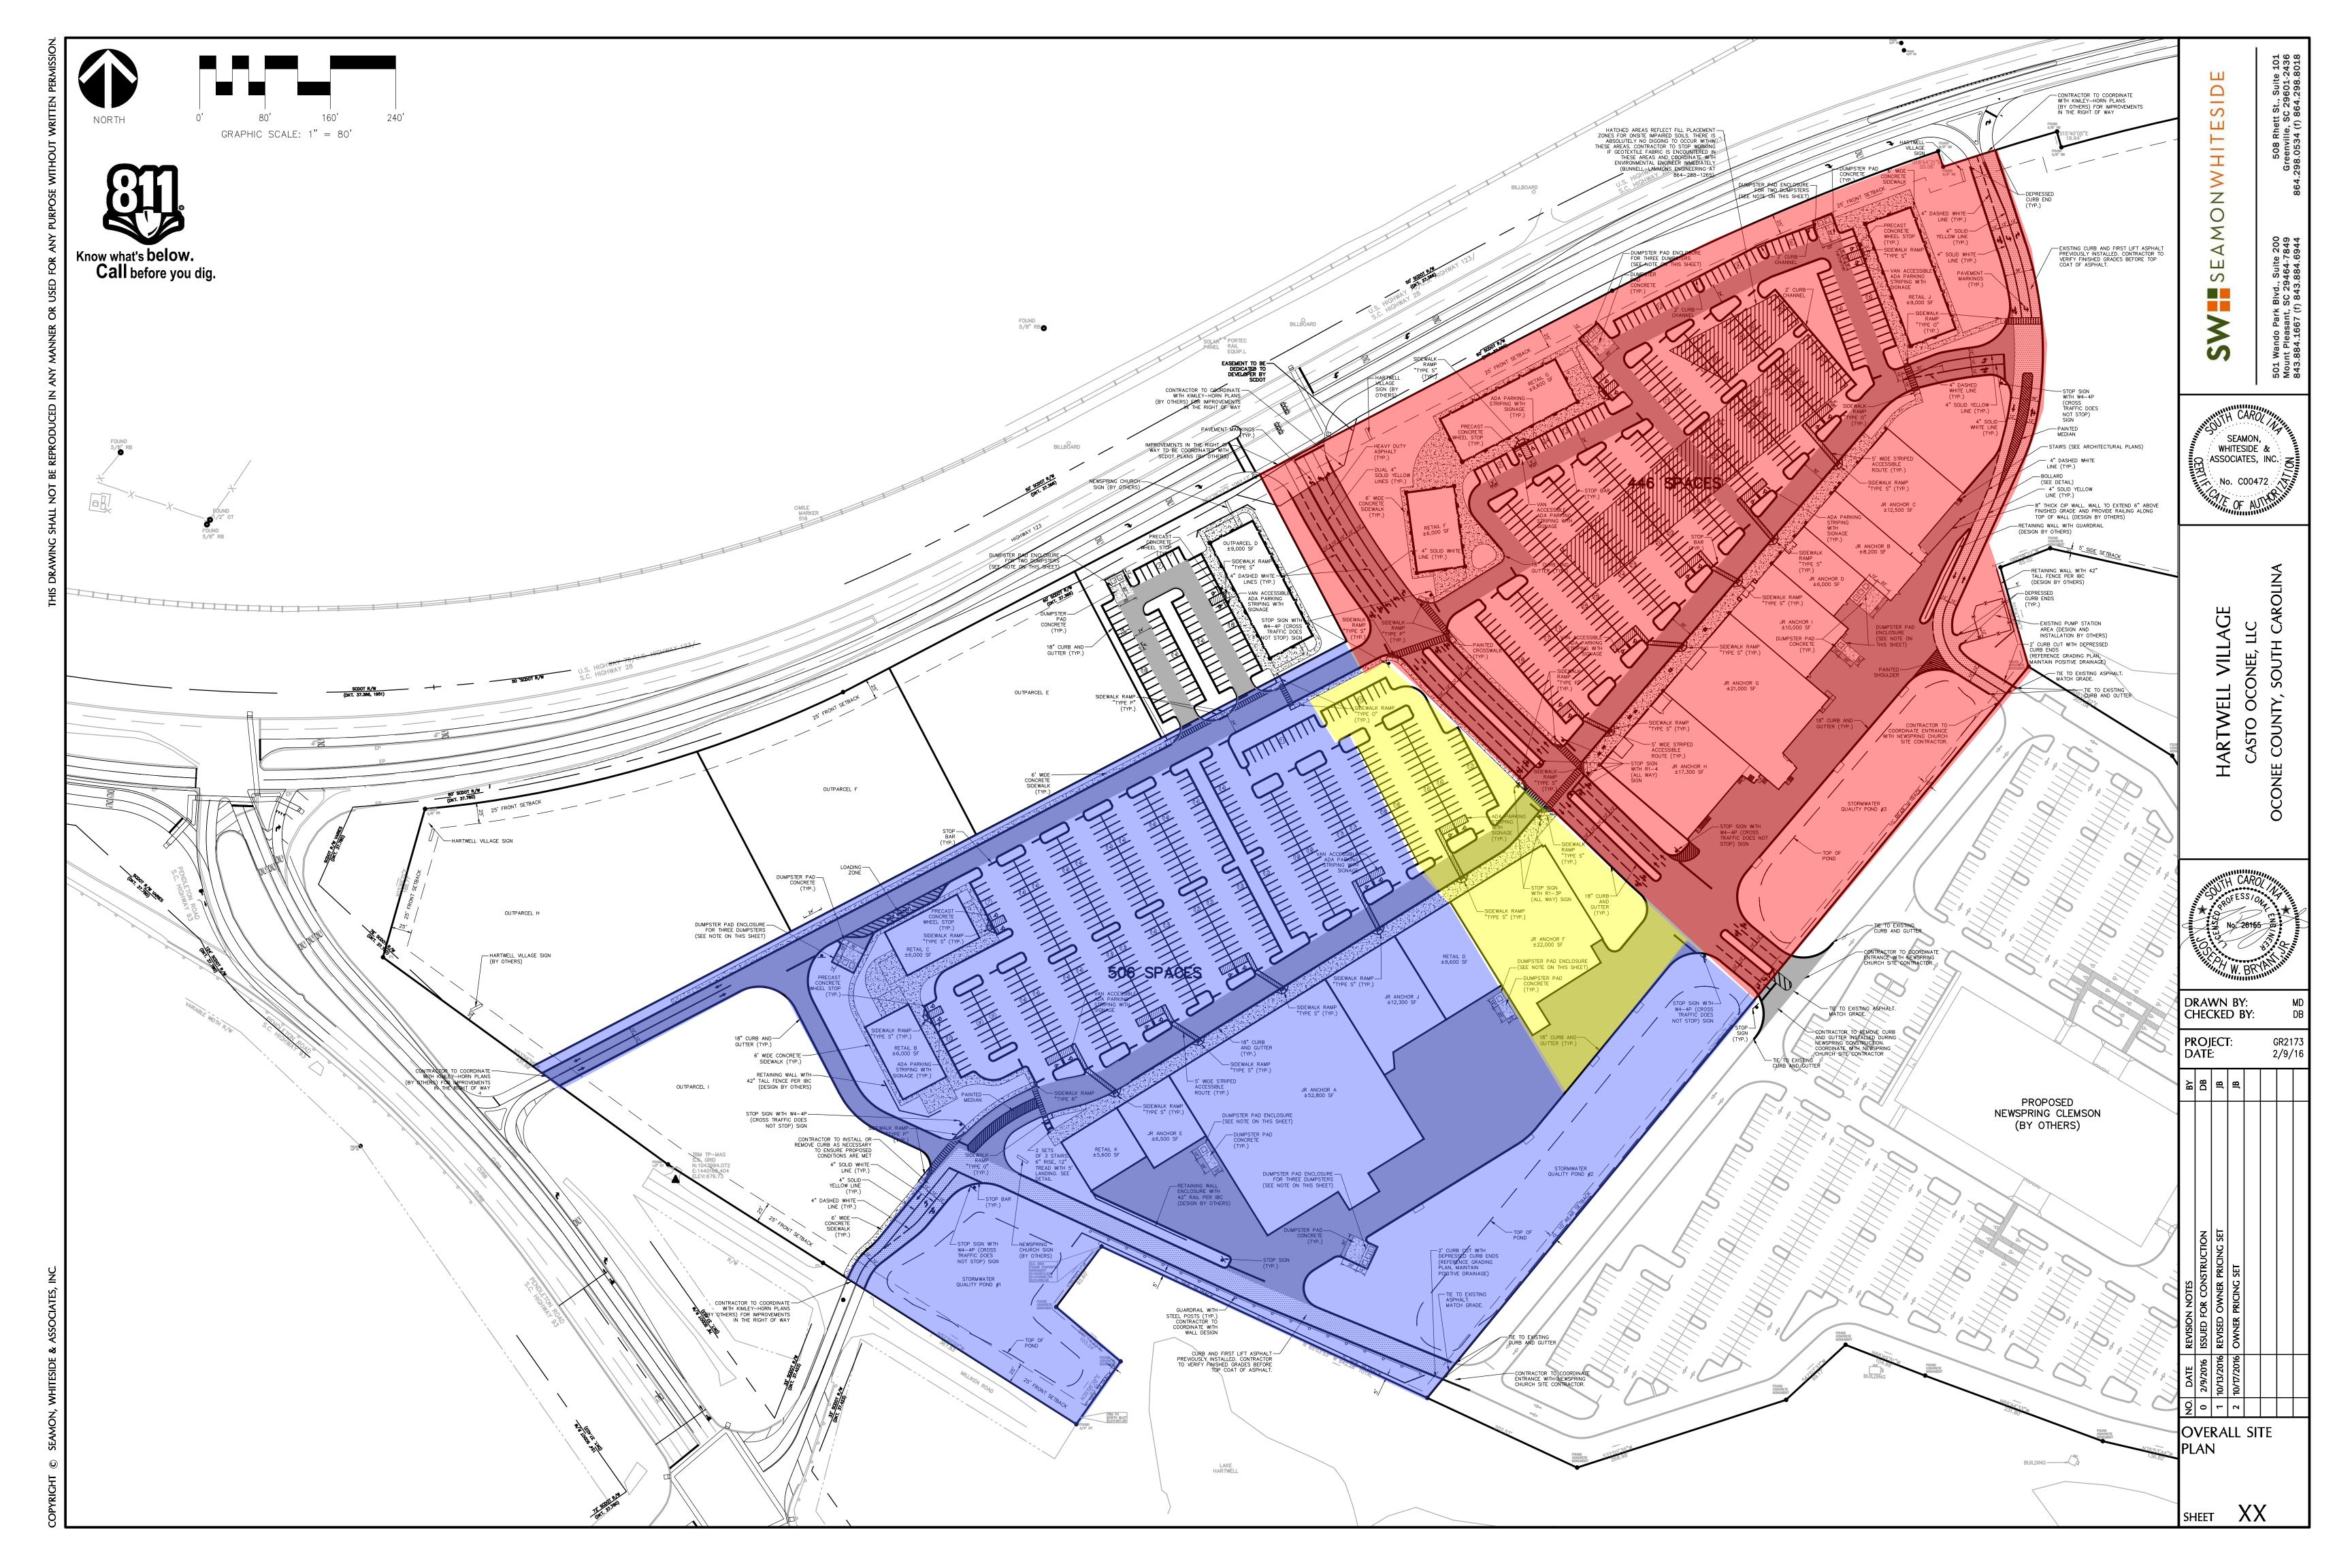

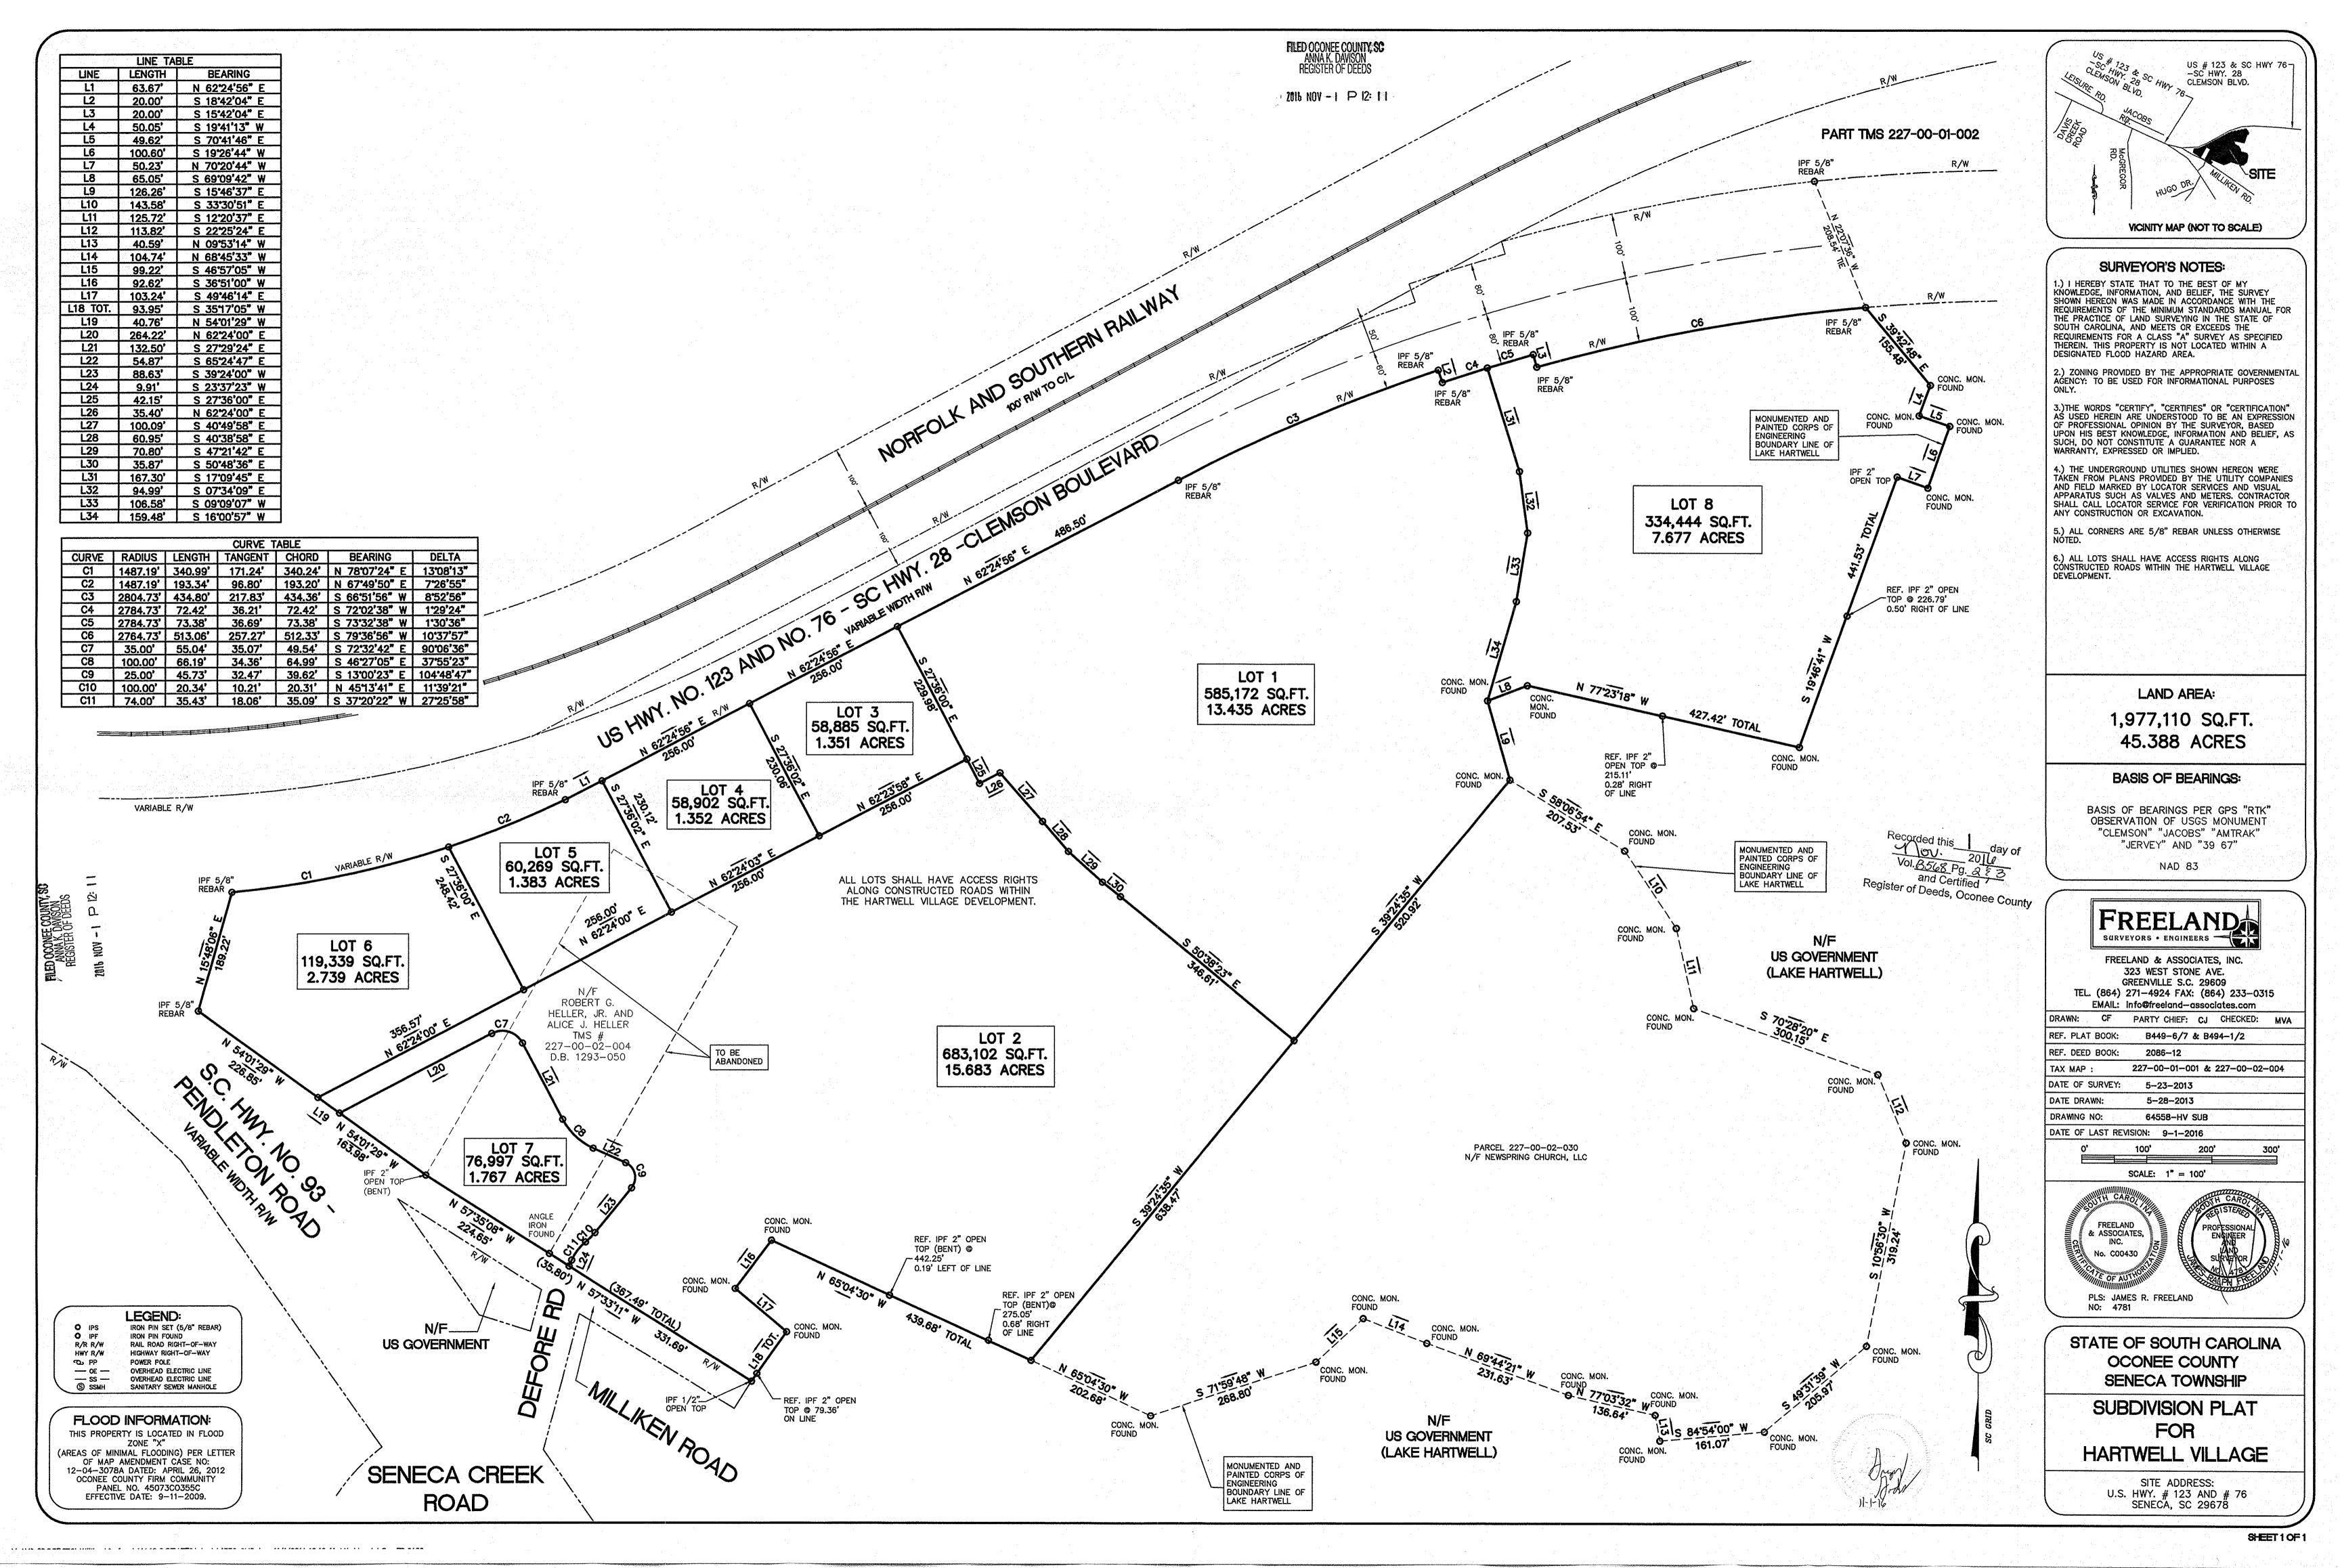













*LOGO COLORS NEED VERIFIED.

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QUANTITY (2) 108"H x 144"W double sided internally illuminated

retainers mounted to 66"H x 144"W x 24" deep stone base by cabinet with painted and embossed pan formed faces and 3"

ACRETEGRACE
PARTIES 75%C
C-277
AC71.07
Y-96.73
G-6.40 MONETH ORANGE SOFT

CLIENT: Moneter Self Storage

1994 Rado Compto Blod Toylors, SC 24001 FAX: 65 ← 24 ← 1627 PRIDATE 164 - 24 ← 0540

www.88GlairSigra.com

EMAIL:

PHONE:

SALESMAN: BRYAN

DESIGNER: BRIANNA

DATE: 4.6.17

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this your responsibility to verify quantities, states, oxions, spelling, and overall concept(s) contained in your overall concept(s). ayout. Any corrections made after production begins will be your Address and responsibility and additional chargos

PLEASE NOTE:

St. Clair Signs is happy to provide one Amy revisions, increafter are subject to complimentary sign layout revision. complimentary sign layout and one graphic design fees at a rate of \$85.00 per hour.

NOTES:

SALES APPROVAL:

CLIENT APPROVAL:

PMS 567 C - CLOSEST MATCH

BLACK

PMS 7578 C

COLOR:

VECTOR NEEDED?

YES:

= SQFT

DATE

DATE

